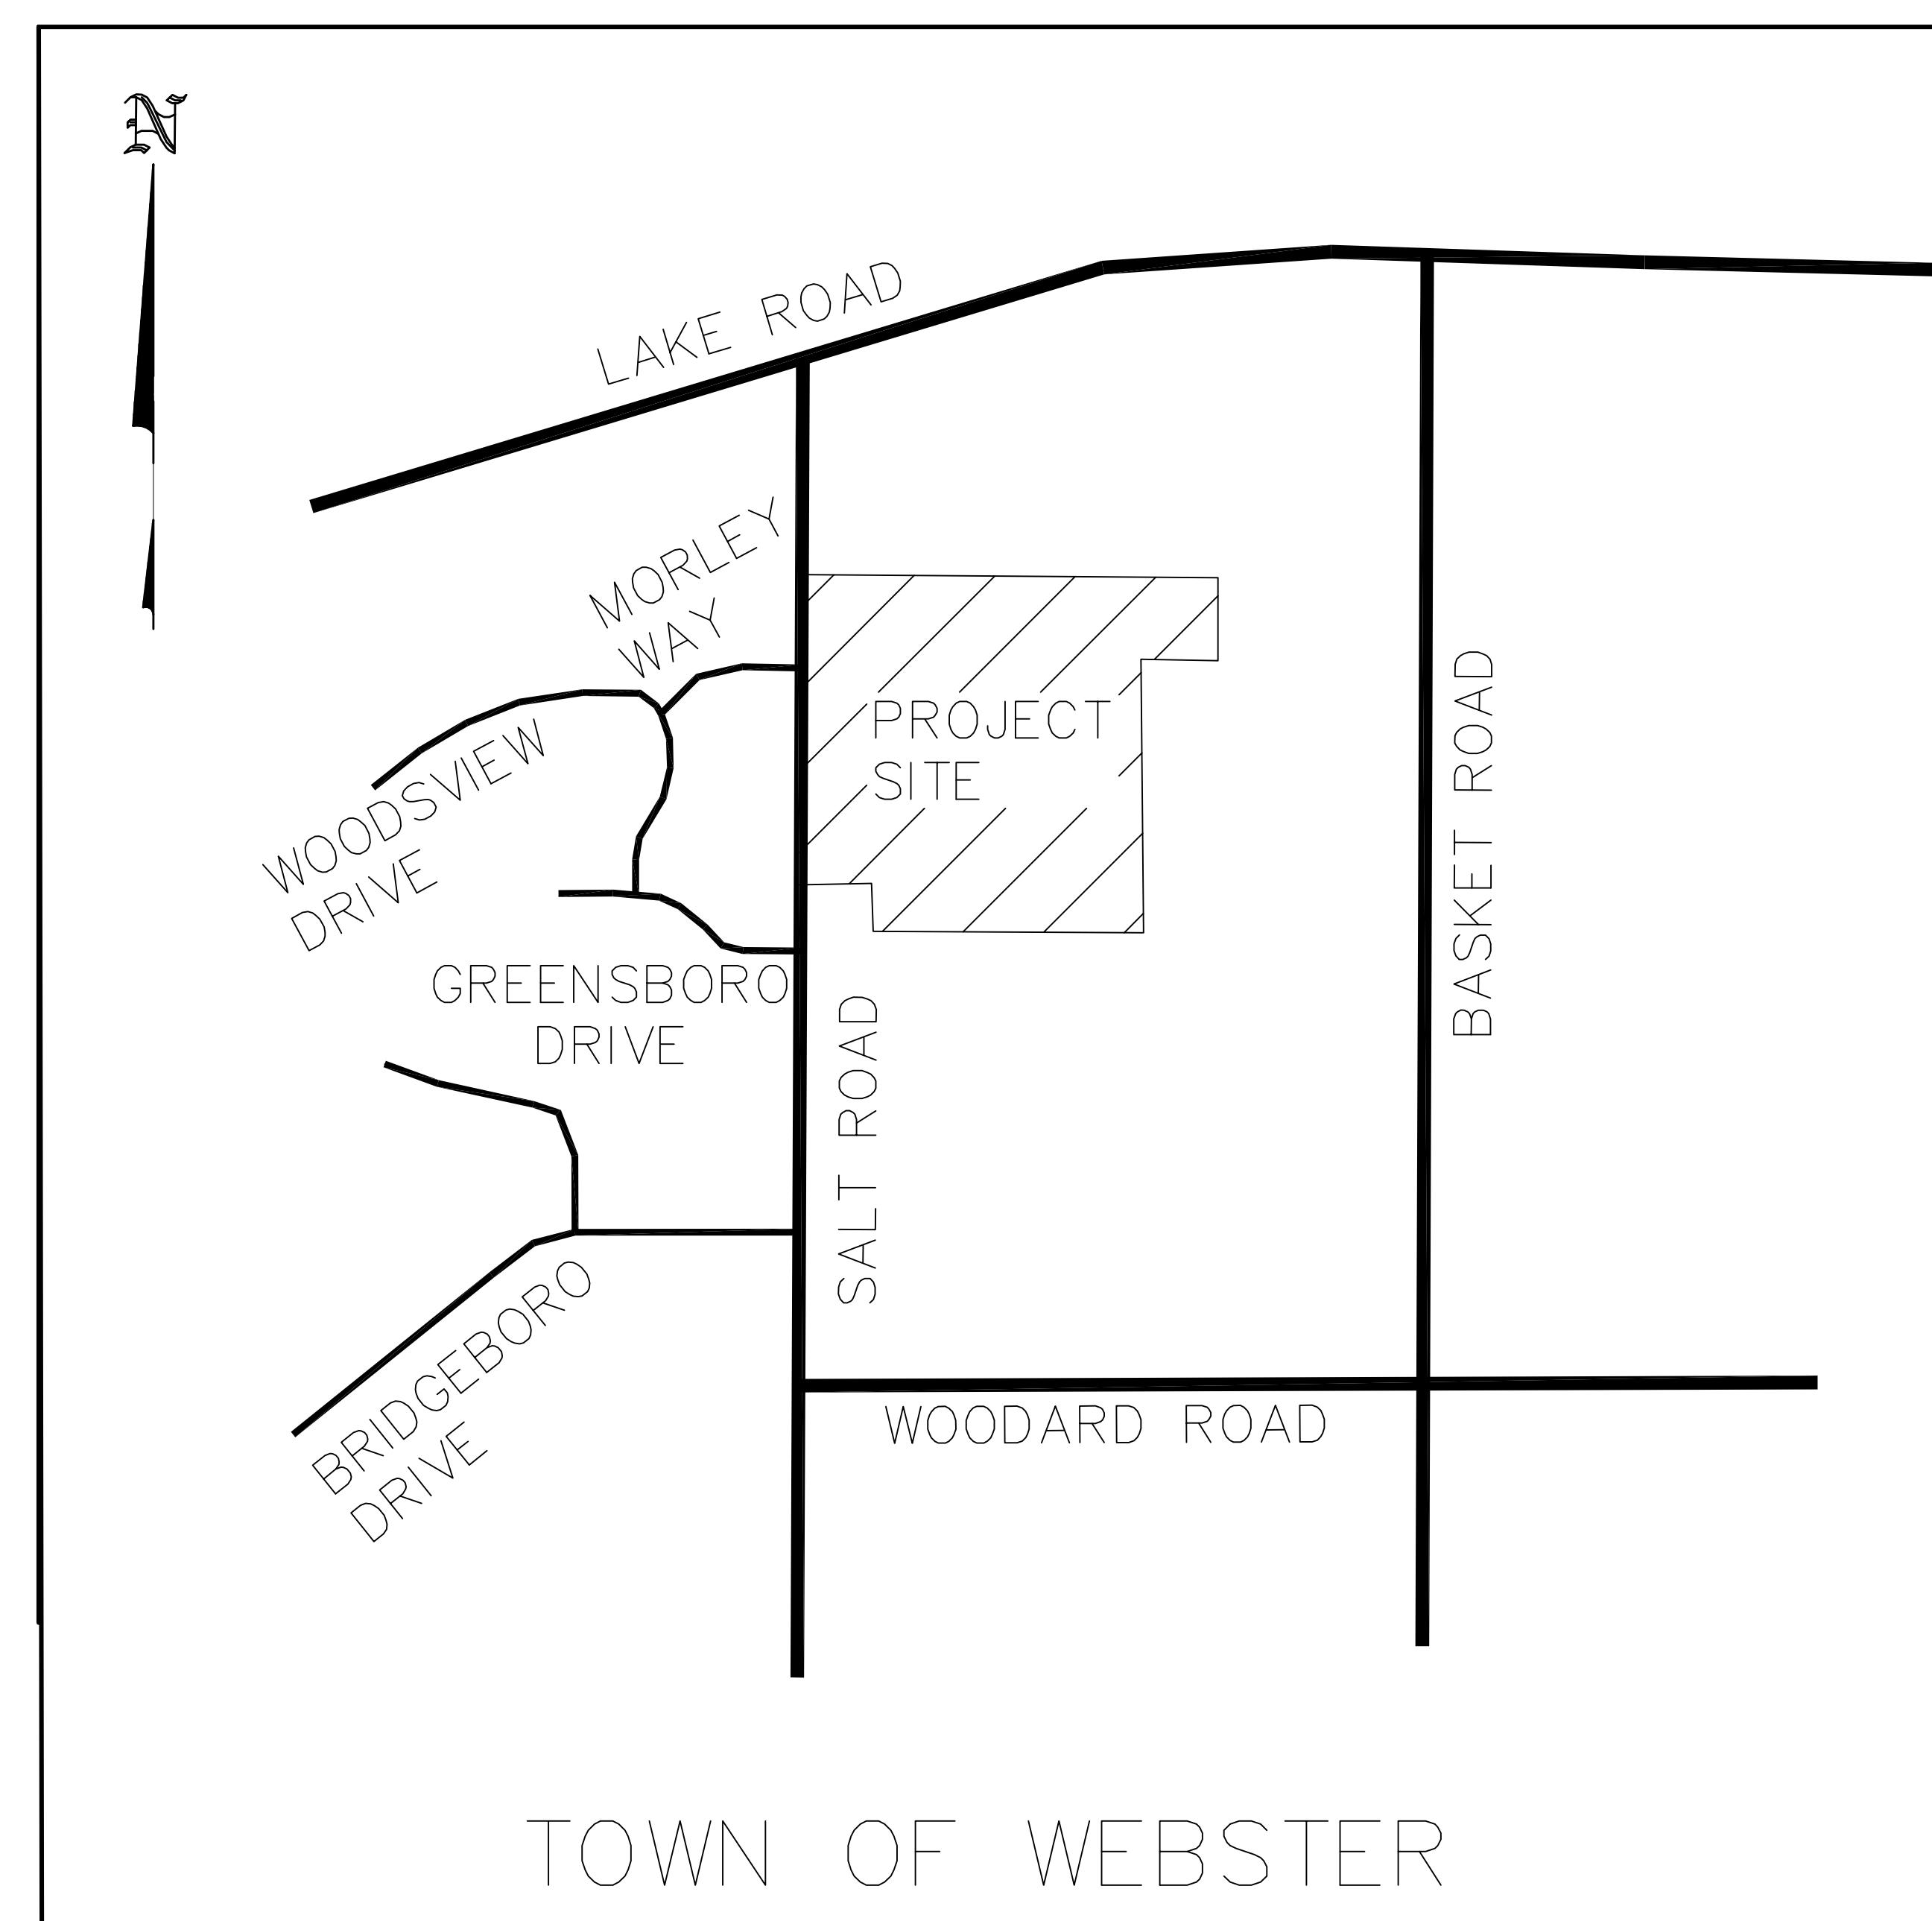


ABERDEEN ESTATES SUBDIVISION

FINAL PHASE 2

TOWN OF WEBSTER
COUNTY OF MONROE
STATE OF NEW YORK



LOCATION SKETCH
N.T.S.

INDEX OF ON-SITE DRAWINGS:



DRAWING NO.	DRAWING NAME
1	COVER SHEET
2	OVERALL PLAN
3	PLAT PLAN
4	UTILITY PLAN
5	GRADING & EROSION CONTROL PLAN
6	PROFILES
7 - 9	DETAILS & NOTES

DSB Engineers and
Architects, P.C.
2394 Ridgeway Avenue, Suite 201, Rochester, New York 14626
ph. 585-271-5230 fax 585-271-3488



PREPARED FOR:
FOREST CREEK EQUITY CORP.
3240 CHILI AVENUE
ROCHESTER, N.Y. 14624

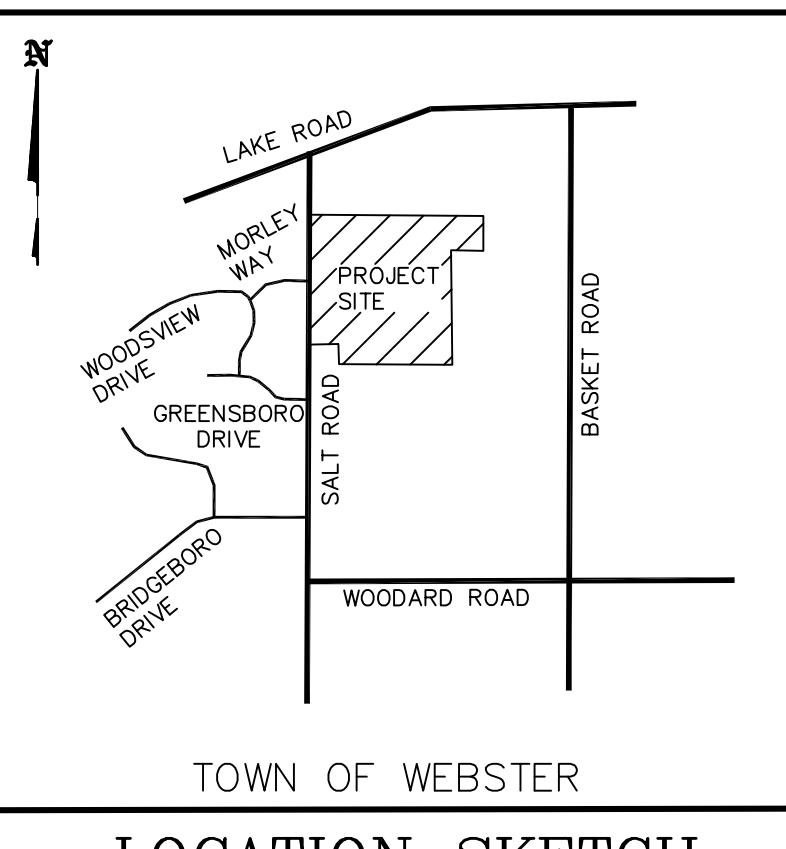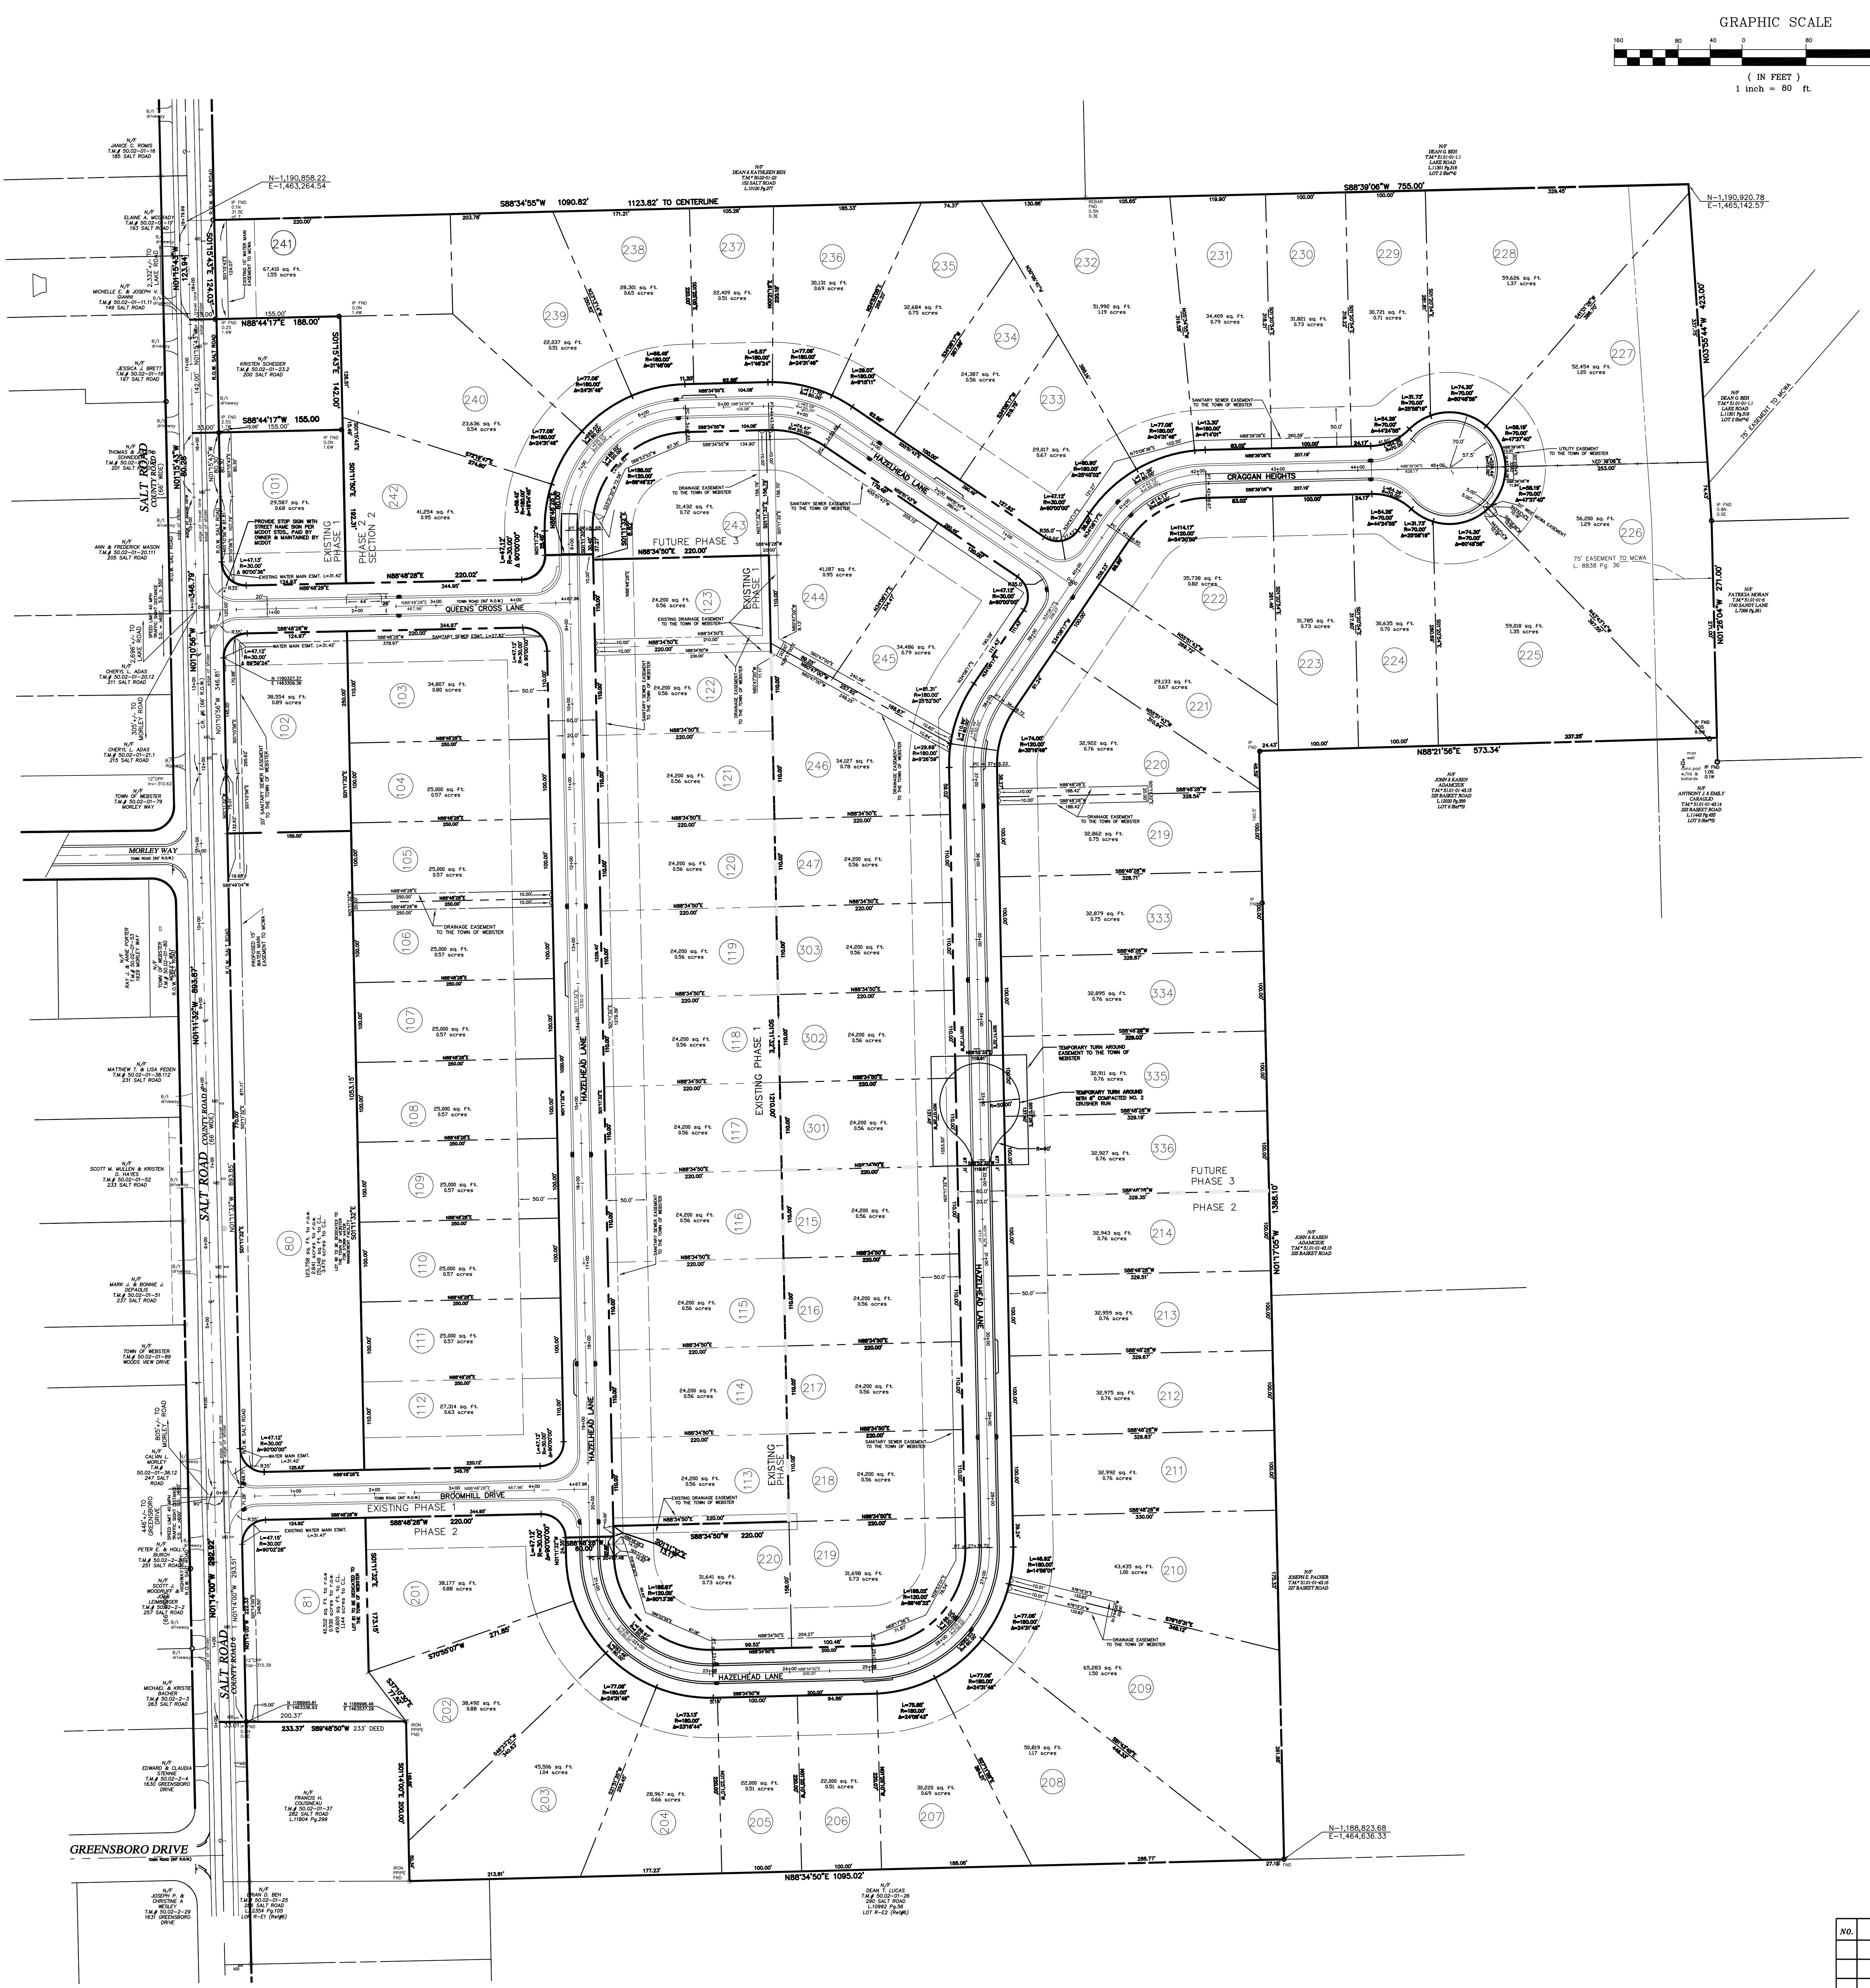01/13/2026



LOCATION SKETCH

N.T.S.

N. I. S.

SITE DATA:

1. TAX ACCT. NO'S.
050.02-01-23.11
2. PARCEL AREA:
EXISTING PHASE 1: 19.60 AC. - 23 LOTS
PHASE 2: 17.10 AC. - 20 LOTS
FUTURE PHASE 3: 52.44 AC. - 36 LOTS

3. EXISTING ZONING: R-3 RESIDENTIAL
4. PROPOSED ZONING: R-3 RESIDENTIAL

LOT WIDTH: (MIN.)	100' (cul-de-sac 55' at front lot line)
LOT SIZE: (MIN.)	22,000 S.F.
SET BACK: FRONT SIDE REAR	50' MIN. (CORNER LOTS 40') 15' MIN. 50' MIN.

APPROVED BY: _____ DATE: _____
PLANNING BOARD CHAIRMAN

APPROVED BY: _____ DATE: _____

APPROVED BY: _____ DATE: _____

NO.	REVISION	DATE



DSB Engineers and
Architects, P.C.

BBD Architects, P.C.
2394 Ridgeway Avenue, Suite 201, Rochester, New York 14626
ph. 585-271-5230 fax 585-271-3488

pi. 585-2/1-5230 July 585-2/1-3408
ERDEEN ESTATES SUBDIVISION

ESTATE SUBDIVISION
S 21 & 23, TOWNSHIP 14, RANGE 4 OF THE PHELPS &
CHASE, TOWN OF WEBSTER, MONROE COUNTY, NEW YORK

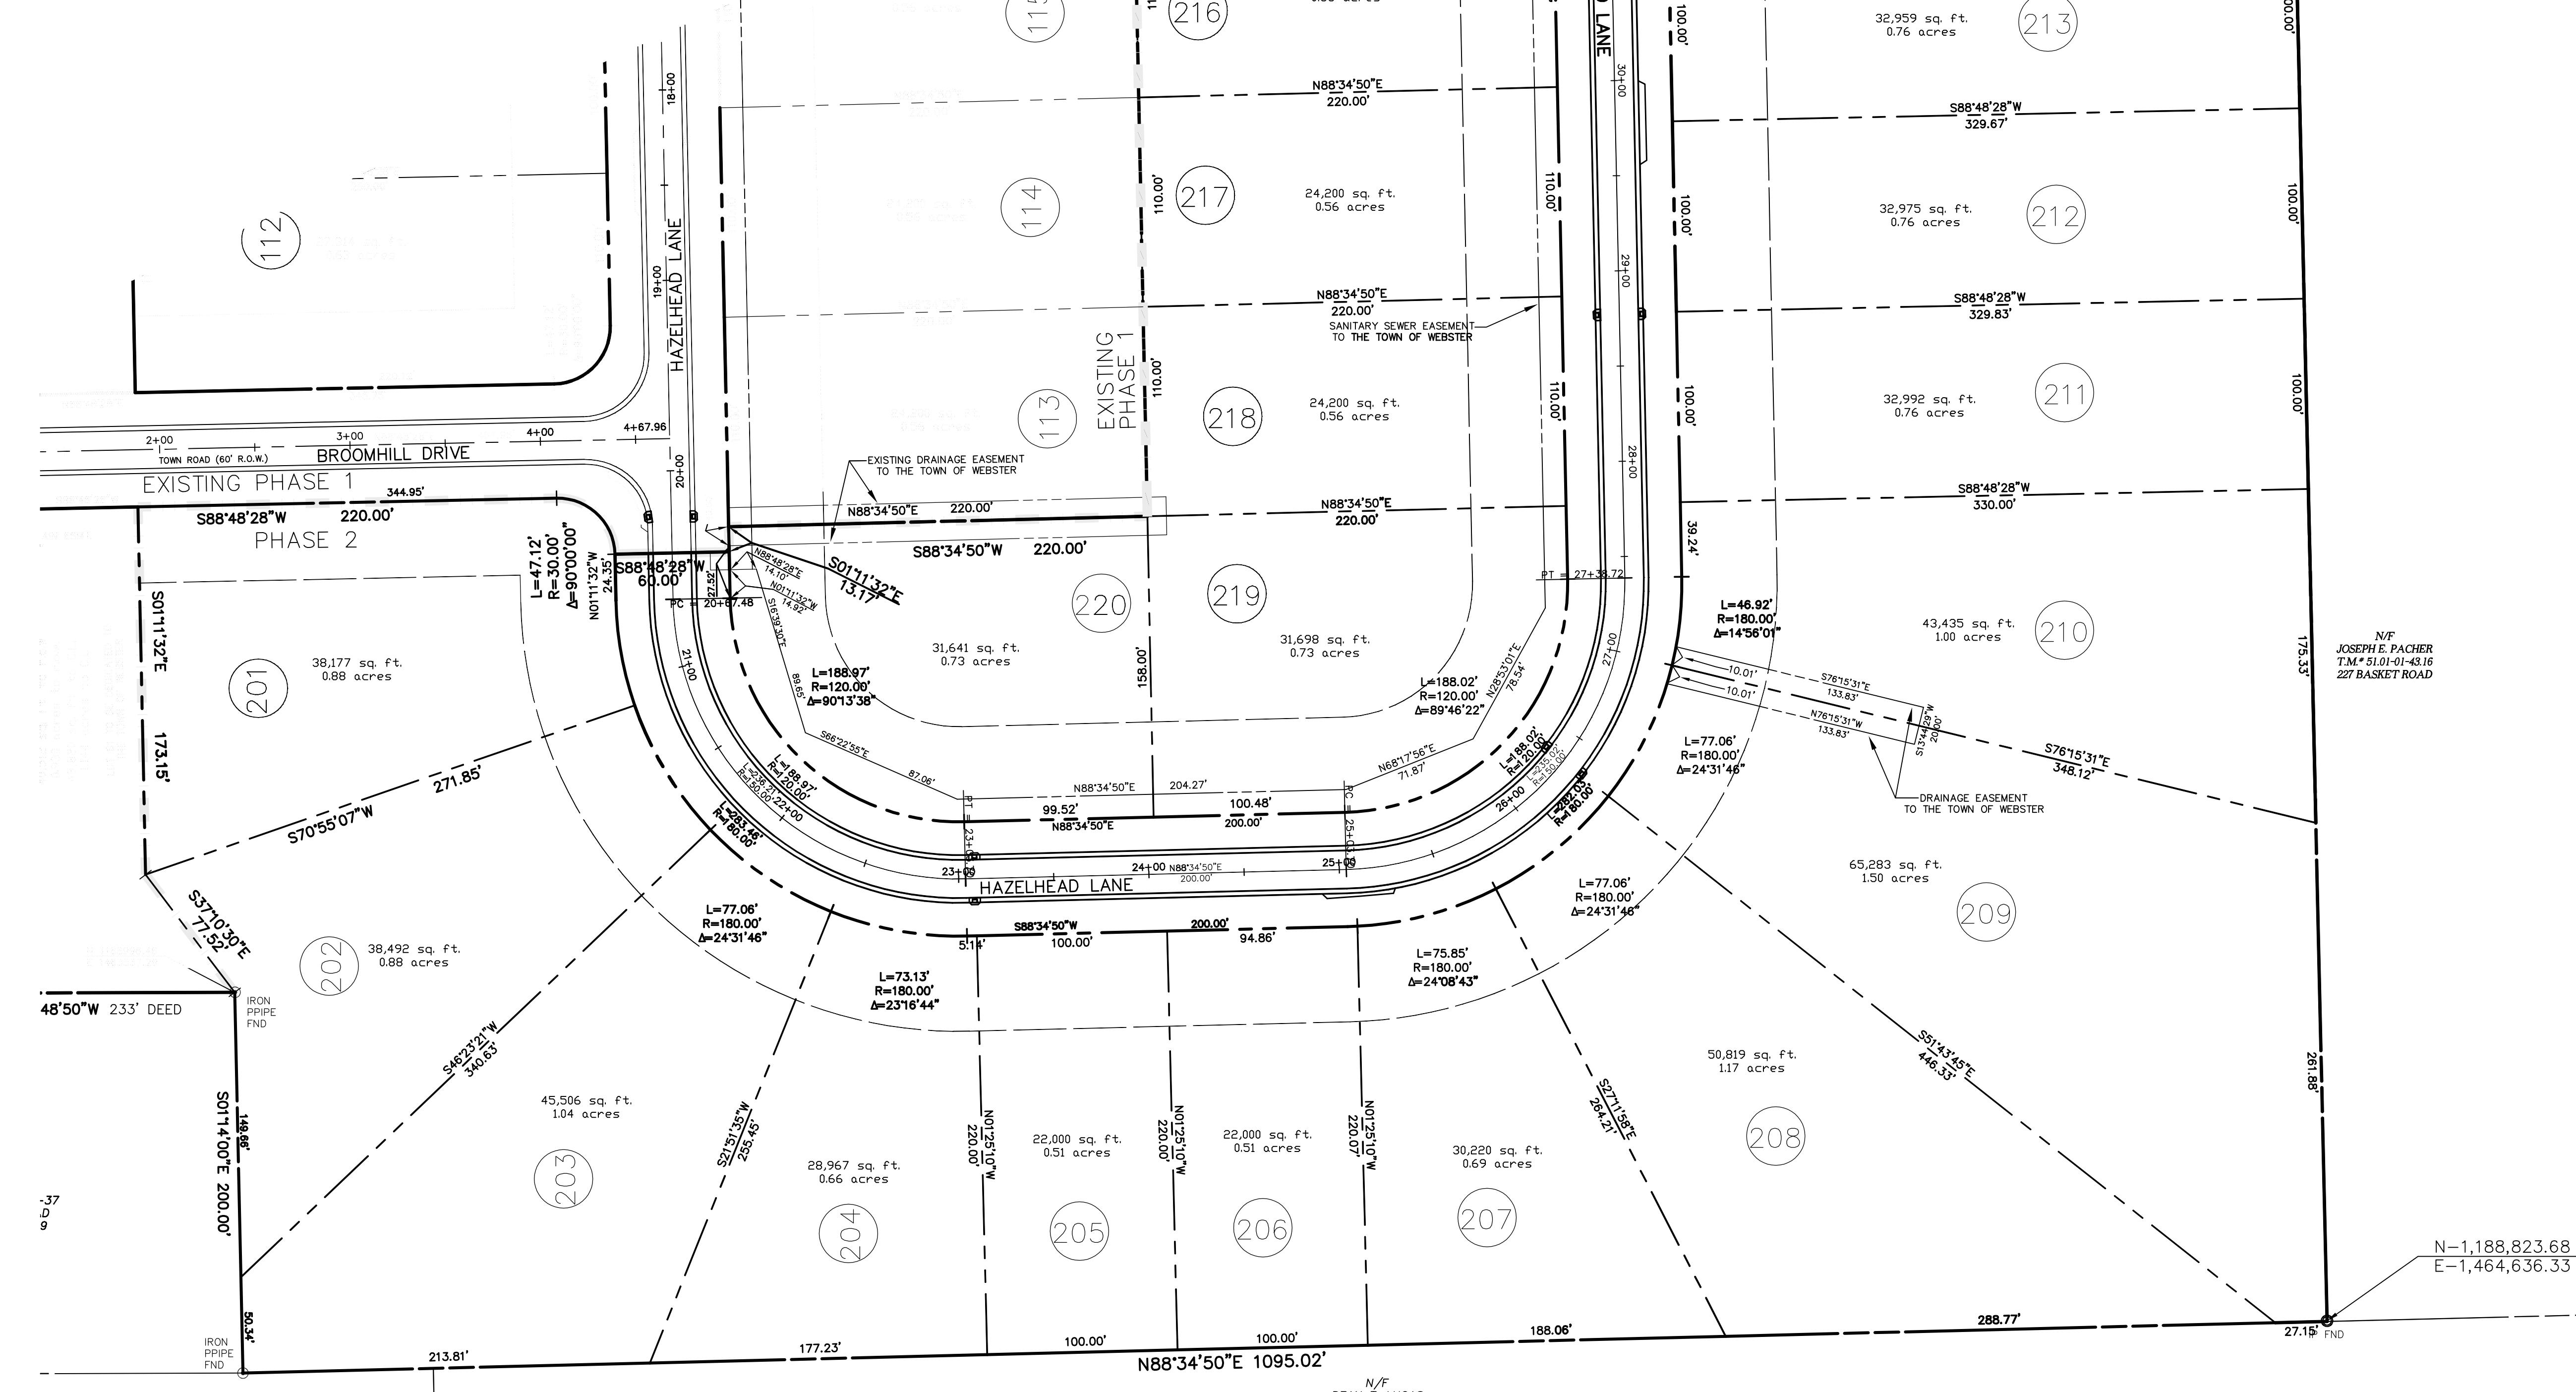
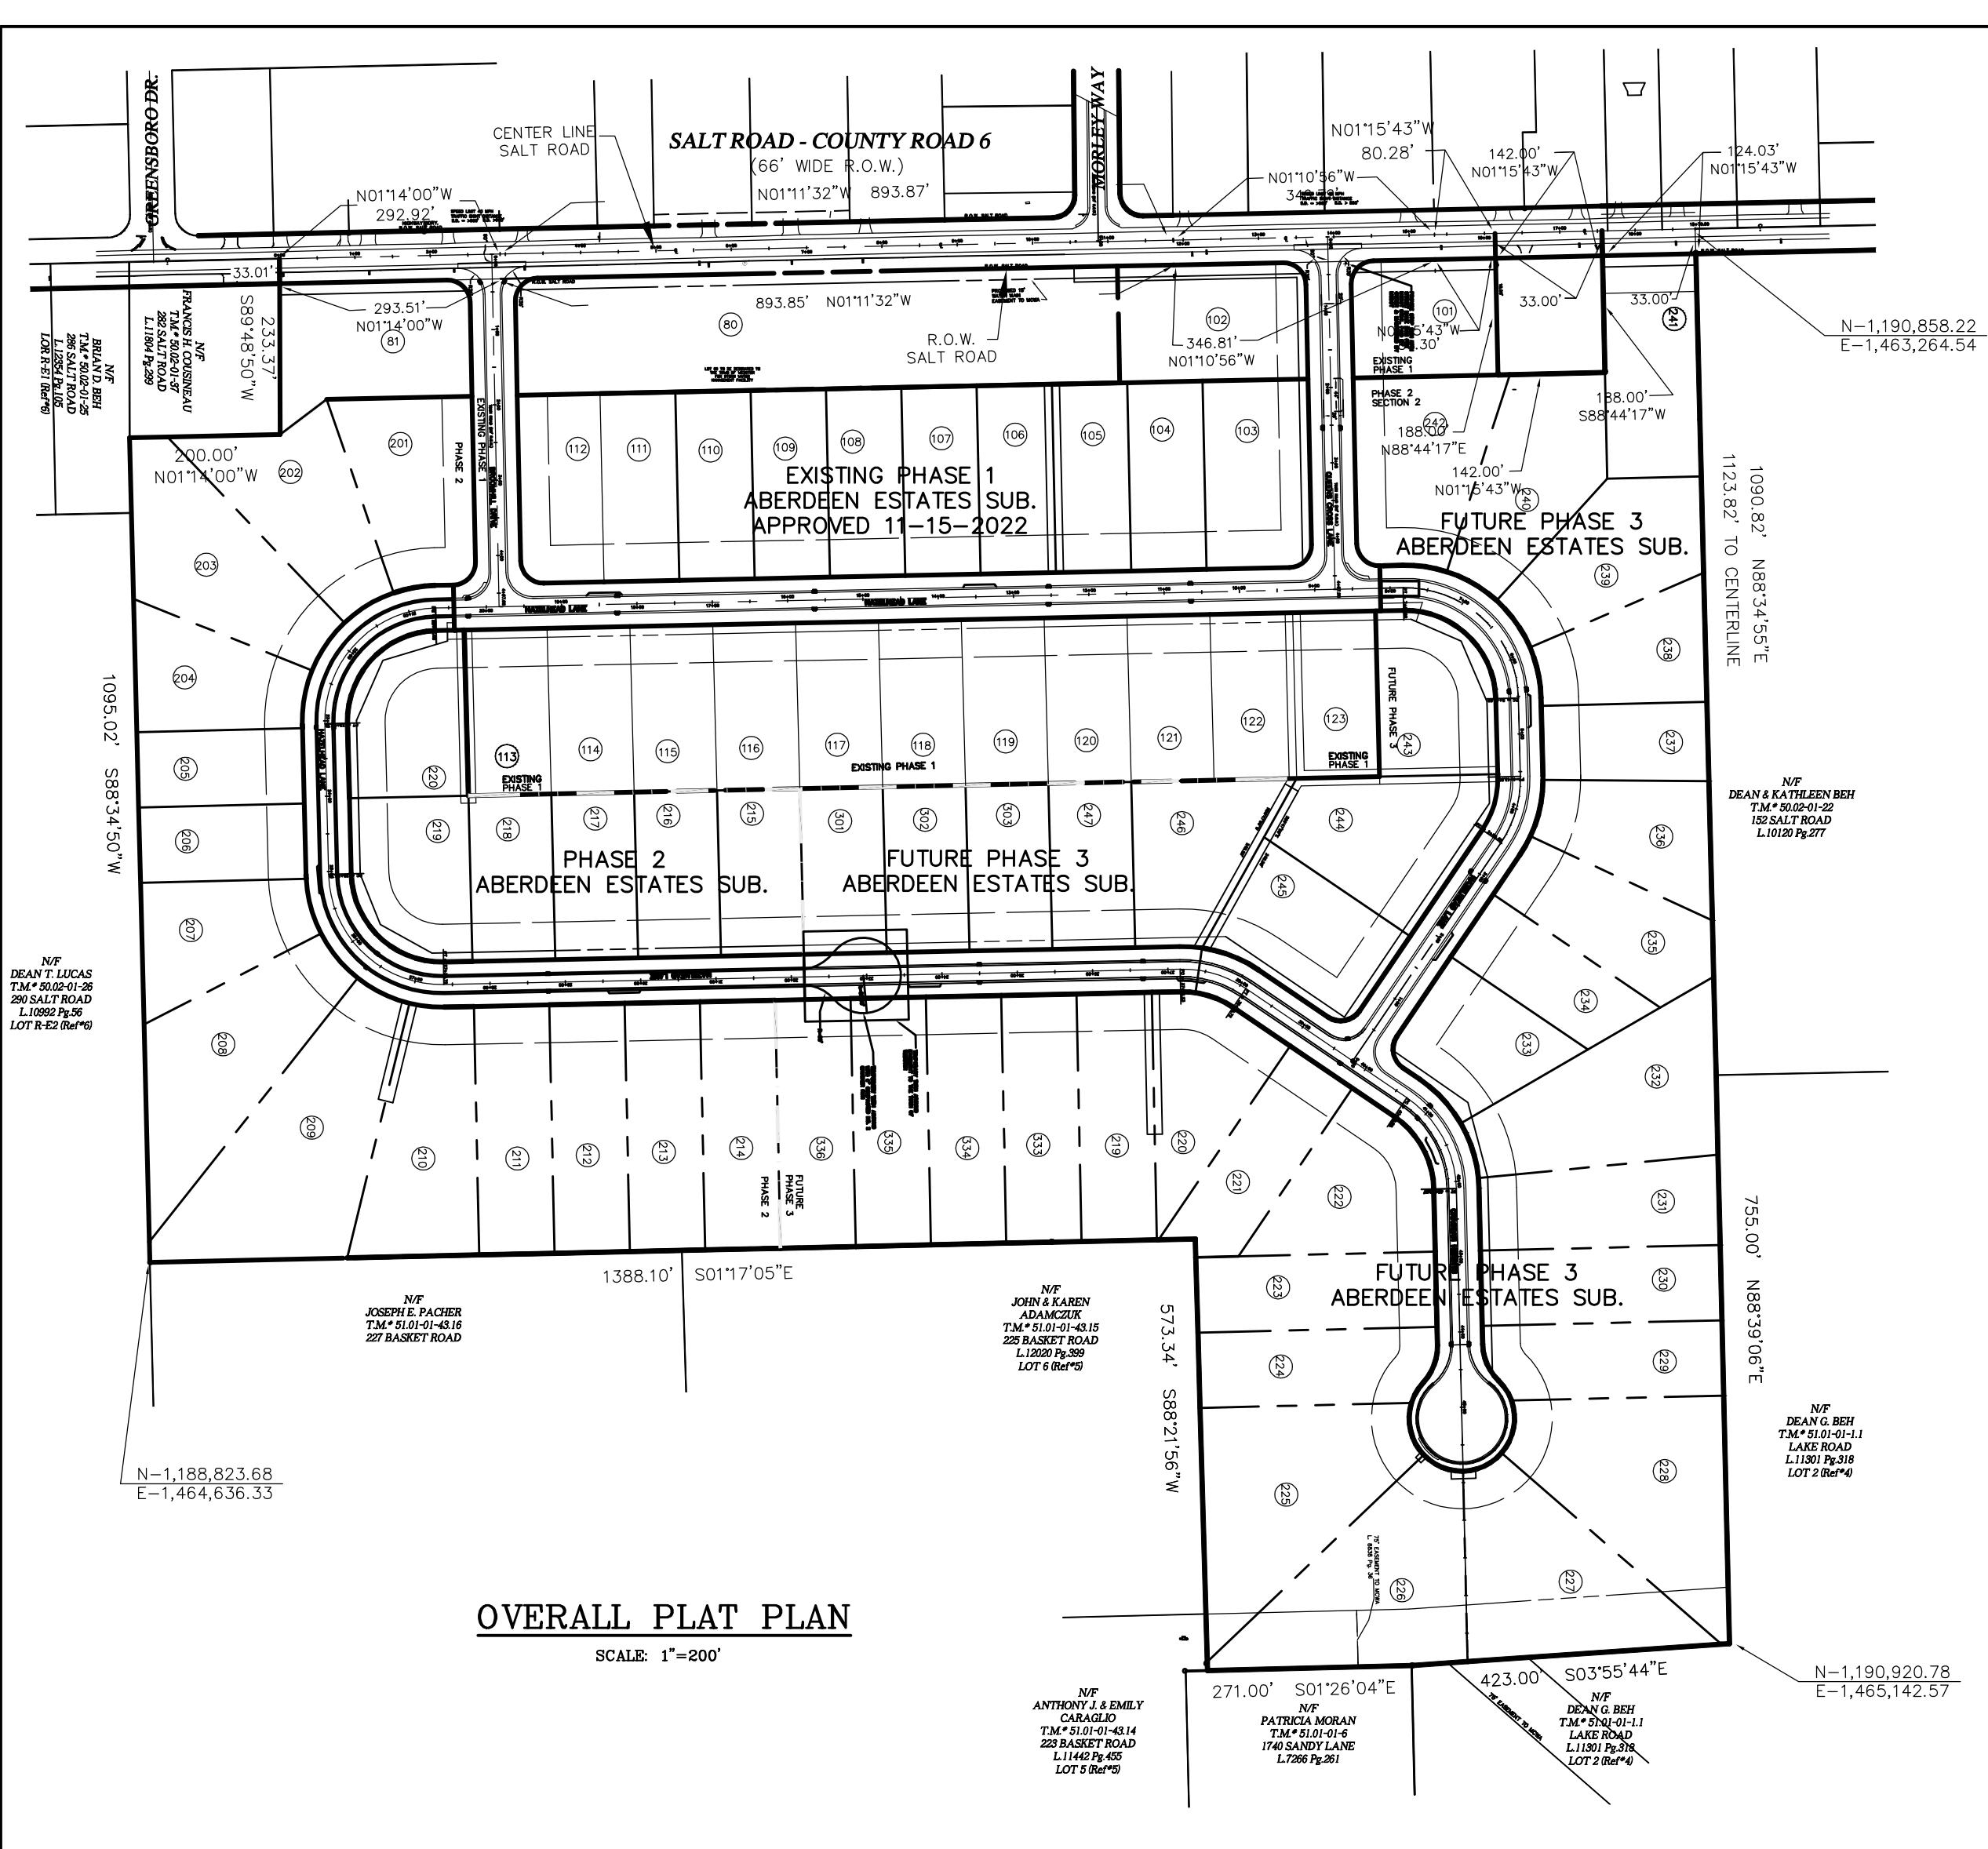
OVERALL PLAT FINAL PHASE 2

FINAL PHASE 2

EST CREEK EQUITY CORP.
10 CHILI AVENUE
CHESTER, N.Y. 14624

BY DESIGN BY APPROVED DATE SCALE DWG.
S. W.E.B. D.E.S. 01/13/26 1"=80' 2 OF

S. W.F.B. D.E.S. 01/15/20 I = 80 2 OF



SURVEY NOTES:
THE HORIZONTAL DATUM IS REFERRED TO AMERICAN DATUM OF 1983 (2011), NYS PL SYSTEM, WEST ZONE (3103). ELEVATIONS SHOWN ARE NAVD88. SURVEY CONTROL POINTS WERE USED TO ENSURE PROCEDURES NECESSARY TO ACHIEVE A POSITIONAL ACCURACY AT THE 95% CONFIDENCE LEVEL NOT EXCEEDING 0.025 FEET. DISTANCES SHOWN ARE GRID DISTANCES, COORDINATES SHOWN ARE GRID COORDINATES, BEARINGS SHOWN ARE GRID BEARINGS. ESTIMATED RTK METHODS FROM CORS STATION NYPF

MONUMENTS:

T.P. 9270(MCGS) N=1,187,407.87 E=814,321.00
N=1,187,447.611 E=1,463,321.00

1132(NYGS)1937 N=1,193,470.01 E=817,000.00
N=1,193,511.031 E=1,465,431.00

1133(NYGS)1937 N=1,193,451.60 E=819,000.00
N=1,193,511.031 E=1,465,431.00

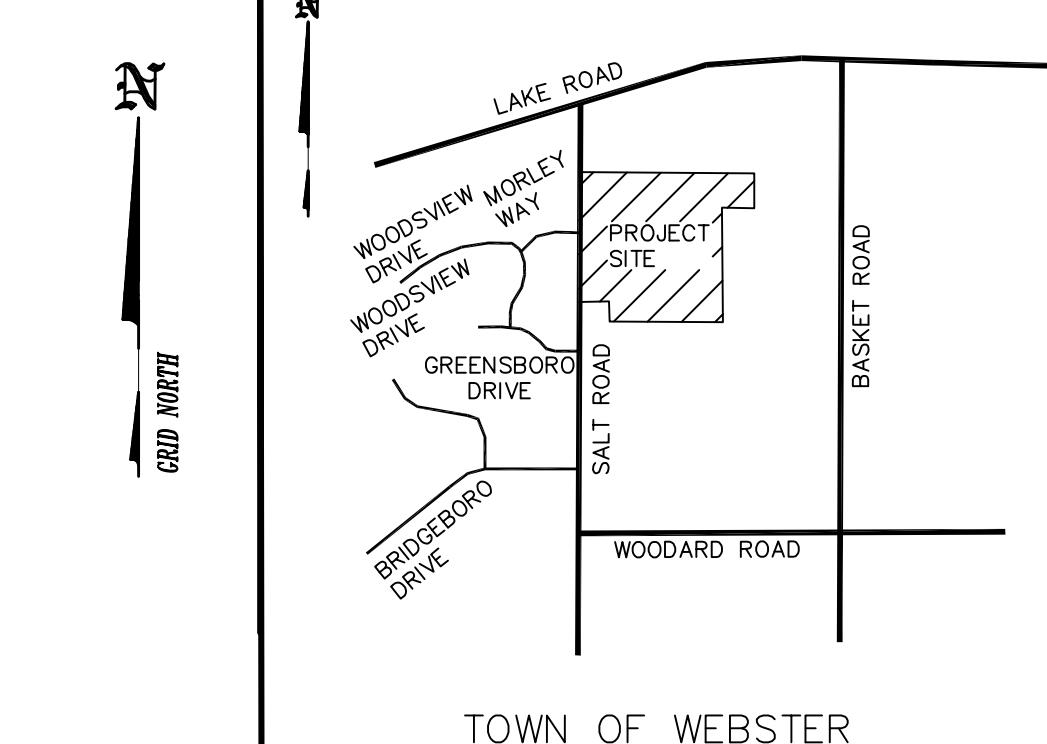
0RTH
0ORDINATE
HEREON ARE
SHED USING
K AND LOCAL
LEVEL NOT
GROUND
RDINATES,
HED BY GPS
10614).

3
MEAS NAD 83

MEAS NAD 83

REFERENCES:

1. CAROLINE SMITH TO WILLIAM M. & MARTHA M. SMITH BY DEED FILED 4/27/1998 AS LIBER 8999 OF DEEDS, PAGE 144.
2. "BRIARWOOD SUBDIVISION - SECTION 2, PHASE A", FILED 9/18/2014 AS LIBER 348 OF MAPS, PAGE 74.
3. "BRIARWOOD SUBDIVISION - SECTION 1", FILED 8/31/2006 AS LIBER 329 OF MAPS, PAGE 2.
4. PLAN OF LAND "THE ESTATE OF ANASTASIA L. MARTIN", FILED 8/23/2012 AS LIBER 344 OF MAPS, PAGE 16.
5. "YERVASI SUBDIVISION - SECTION 2", FILED 6/21/2000 AS LIBER 304 OF MAPS, PAGE 69.
6. "RESUBDIVISION OF WOODARD MANOR, INC., LOTS D & E", FILED 7/17/1980 AS LIBER 214 OF MAPS, PAGE 29.
7. "WOODARD MANOR SUBDIVISION - SECTION 2", FILED AS LIBER 174 OF MAPS, PAGE 76.
8. "YAEGER SUBDIVISION - SECTION 2", FILED 2/25/2000 AS LIBER 303 OF MAPS, PAGE 40.



LOCATION SKETCH

N.T.S.

LEGEND:

— BOUNDARY LINE
— CENTERLINE OF ROAD
— EXIST. R.O.W. LINE
— EXIST. PROPERTY LINE
— EXIST. PAVEMENT
— PROP. R.O.W.
— PROP. LOT LINE
— SETBACK LINE
— EXIST. BUILDING LINE
— EXIST. EASEMENT LINE
— PROP. EASEMENT LINE
LOT NUMBER

CONDITIONS OF APPROVAL FOR REALTY SUBDIVISIONS

MONROE COUNTY DEPARTMENT OF PUBLIC HEALTH APPROVAL FOR THIS REALTY SUBDIVISION IS GRANTED ON CONDITION THAT:

THE PROPOSED FACILITIES FOR WATER SUPPLY AND SEWAGE TREATMENT ARE INSTALLED IN CONFORMITY WITH THE APPROVED PLANS ON FILE WITH THE MONROE COUNTY DEPARTMENT OF PUBLIC HEALTH (MCDPH).

AN ORIGINAL REALTY SUBDIVISION MAP APPROVED THIS DATE SHALL BE FILED IN THE OFFICE OF THE CLERK OF MONROE COUNTY PRIOR TO OFFERING LOTS FOR SALE.

THE OWNER OF THE REALTY SUBDIVISION SHALL FURNISH EACH PURCHASER OF LOT WITH A COPY OF THE APPROVED PLAN OR, IN THE CASE OF SALE OF DEVELOPED LOTS, THE OWNER OF THE REALTY SUBDIVISION SHALL FURNISH EACH PURCHASER WITH AN ACCURATE "AS-BUILT" PLAN DEPICTING ALL INSTALLED FACILITIES INCLUDING SEWAGE, STORM WATER AND WATER SUPPLY.

ADEQUATE EROSION/SILTATION CONTROL MEASURES SHALL BE EMPLOYED PRIOR TO AND DURING CONSTRUCTION. IF THE PROJECT WILL RESULT IN THE DISTURBANCE OF ONE ACRE OR MORE, COVERAGE UNDER THE NYSDEC SPDES GENERAL PERMIT GP-0-15-002 FOR STORMWATER DISCHARGES FOR CONSTRUCTION ACTIVITIES SHALL BE OBTAINED.

NO LOT OR REMAINING LAND (IF APPLICABLE) SHALL BE SUBDIVIDED WITHOUT PLANS FOR SUCH RE-SUBDIVISION BEING SUBMITTED TO AND APPROVED BY THE MCDPH.

PLAN APPROVAL IS LIMITED TO 5 YEARS. TIME EXTENSIONS FOR PLAN APPROVAL MAY BE GRANTED BY THE MCDPH BASED UPON DEVELOPMENT FACTS AND THE REALTY SUBDIVISION REGULATIONS IN EFFECT AT THAT TIME. A NEW PLAN SUBMISSION MAY BE REQUIRED TO OBTAIN A TIME EXTENSION.

PRIVATE WELLS AND PRIVATE ON-SITE WASTEWATER TREATMENT SYSTEMS SHALL NO LONGER BE CONSTRUCTED OR USED AFTER PUBLIC FACILITIES BECOME AVAILABLE.

**Monroe County Department of Public Health
Realty Subdivision Approval**

This is to certify that approved plans for Water Supply and Sewage Disposal for this project are on file in the office of the Monroe County Department of Public Health. Consent is hereby given for the filing of this map in the Monroe County Clerk's Office in accordance with Article III of the Monroe County Sanitary Code

Director of Public Health

SITE DATA

- SITE DATA.

1. TAX ACCT. NO'S.
050.02-01-23.11

2. PARCEL AREA:

EXISTING PHASE 1:
PHASE 2: 1
FUTURE PHASE 3: 52

- APPROVED BY: _____ DATE: _____
PLANNING BOARD CHAIRPERSON

APPROVED BY: _____ DATE: _____
COMMISSIONER OF PUBLIC WORKS

APPROVED BY: _____ DATE: _____
TOWN ASSESSOR

APPROVED BY: _____ DATE: _____
FIRE MARSHAL

APPROVED BY: _____ DATE: _____
HIGHWAY SUPERINTENDENT

APPROVED BY: _____ DATE: _____

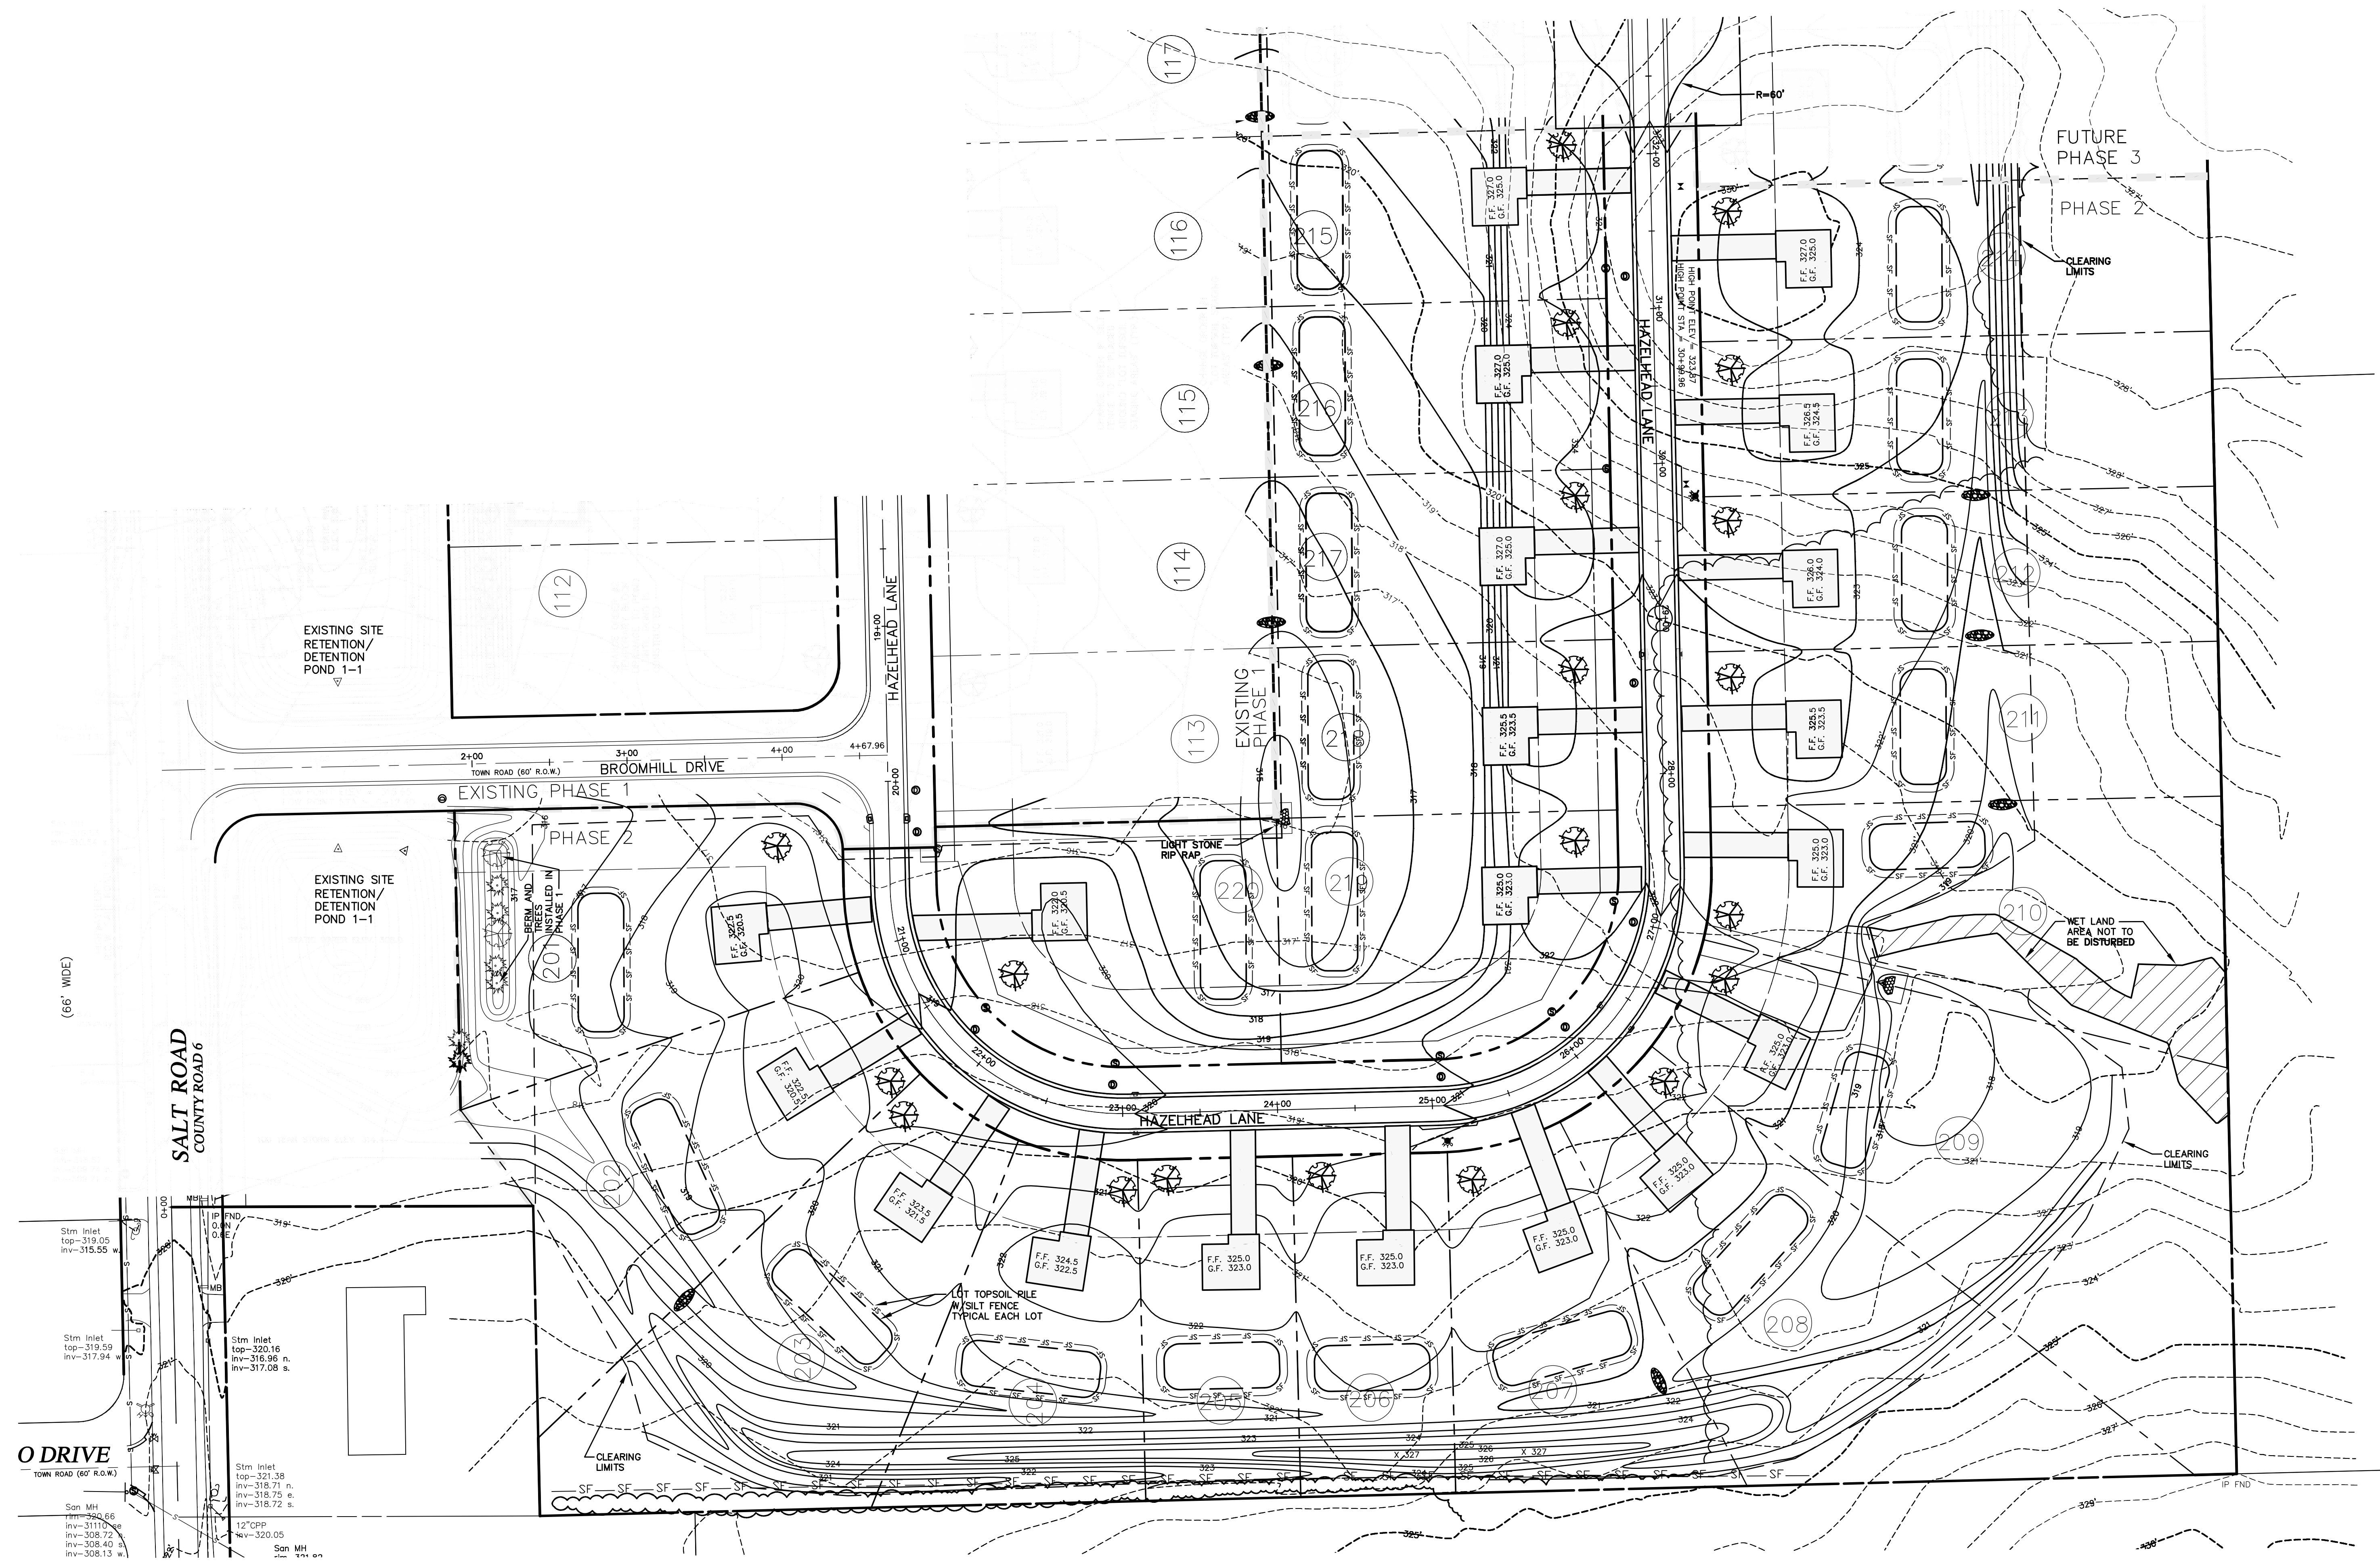
DSB Engineers and
Architects, P.C.

degway Avenue, Suite 201, Rochester, New York 14626
ph. 585-271-5230 fax 585-271-3488

PLAT PLAN

**PLAT PLAN
FINAL PHASE 2**


R, N.Y. 14624



GRAPHIC SCALE
(IN FEET)
1 inch = 50 ft.

LEGEND:

BOUNDARY LINE	DEEP HOLE LOCATION
CENTERLINE OF ROAD	
EXIST. R.O.W. LINE	CHECK DAM
EXIST. PROPERTY LINE	
EXIST. PAYMENT	
PROP. R.O.W.	
PROP. LOT LINE	P.I. SILT FENCE PROTECTION
SETBACK LINE	C.B. INLET PROTECTION
EXIST. BUILDING LINE	EXIST. TREE LINE
EXIST. EASMENT LINE	LAW TREE/NEW TREE
EXIST. FASMENT LINE	
EXIST. CONTOUR LINE	
PROP. SPOT ELEVATION	LOT TYPING LINE / SILT FENCE
— 641 —	
— SF — + 641.5 —	
— SF — SF — SF — SF —	PROP. SILT FENCE
— SF — SF — SF — SF —	PROP. SILT FENCE

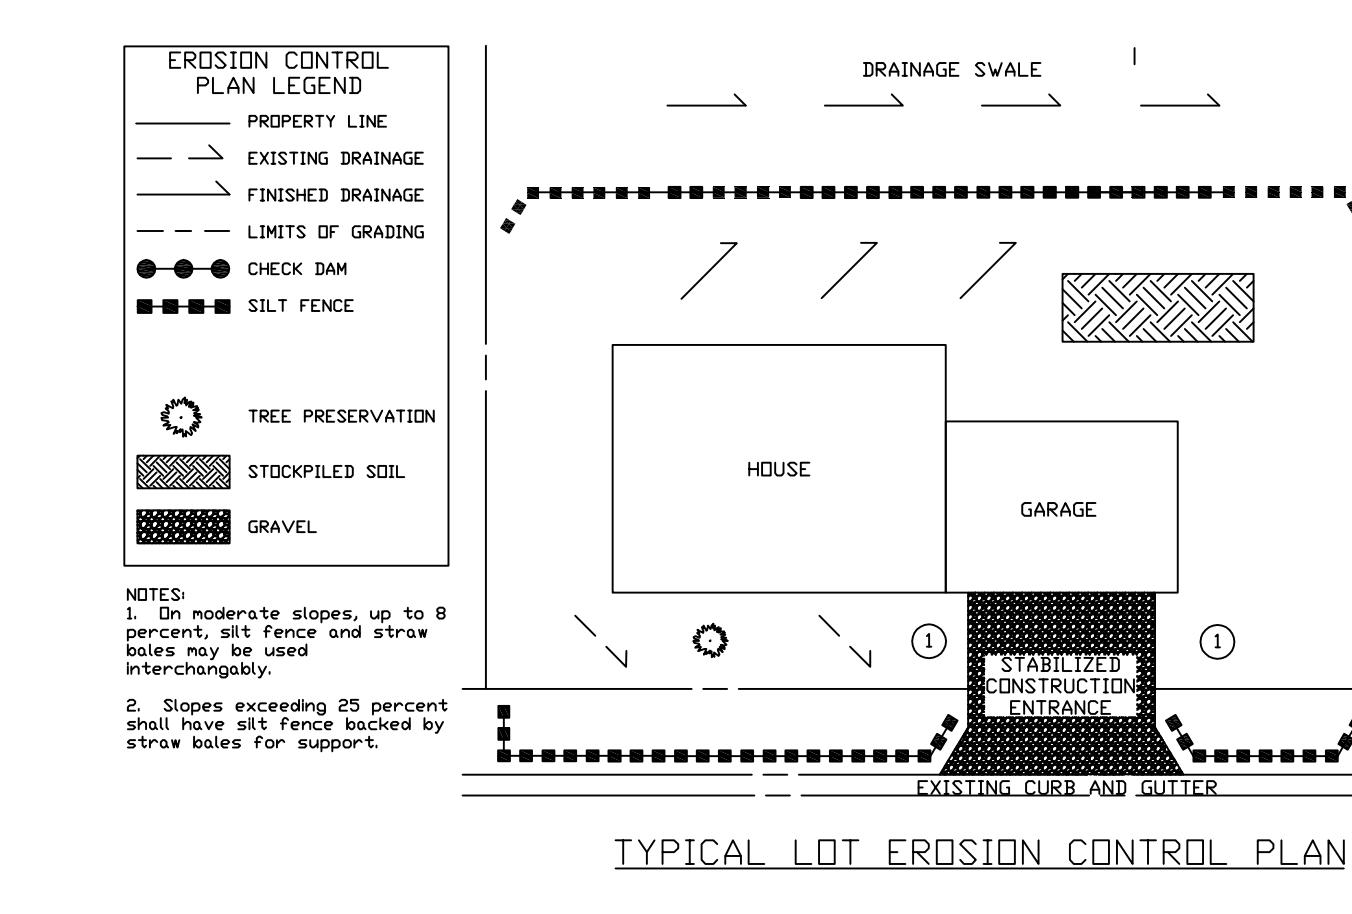

TYPICAL LOT EROSION CONTROL PLAN

CERTIFICATION OF COMPLIANCE WITH SPDES GENERAL PERMIT # GP-0-25-001

I HEREBY CERTIFY THAT I UNDERSTAND AND AGREE TO COMPLY WITH THE TERMS AND CONDITIONS OF THE SWPPP AND AGREE TO IMPLEMENT ANY CORRECTIVE ACTIONS IDENTIFIED BY THE TOWN AND PROJECT ENGINEER. I FURTHER CERTIFY THAT THE OWNER OR OPERATOR MUST COMPLY WITH THE TERMS AND CONDITIONS OF THE NEW YORK STATE POLLUTANT DISCHARGE ELIMINATION SYSTEM GENERAL PERMIT FOR STORMWATER DISCHARGE AND THAT THE OWNER OR OPERATOR WILL NOT ALLOW ANYONE TO CAUSE OR CONTRIBUTE TO A VIOLATION OF WATER QUALITY STANDARDS. FURTHER, I CERTIFY THAT THE SUBMISSION OF INACCURATE INFORMATION IS A VIOLATION OF THE REFERENCED PERMIT AND THE LAWS OF THE STATE OF NEW YORK AND COULD SUBJECT ME TO CRIMINAL, CIVIL AND OR ADMINISTRATIVE PROSECUTION.

OWNER/OPERATOR(S): _____

CONTACTOR(S): _____

LOT TREE LIST			
SPECIES	TYPE (COMMON NAME)	SIZE	SPACING
MAPLE	RED SUNSET SWEET GUM CRIMSON KING AUTUMN BLAZE	2" CAL	AS SHOWN
PEAR	CLEVELAND SELECT RED SPIRE ARISTOCRAT CAPITAL	2" CAL	AS SHOWN
LINDEN	LITTLE LEAF	2" CAL	AS SHOWN
LOCUST	SHADEMASTER	2" CAL	AS SHOWN

NOTES:

1. ALL TREES SHALL HAVE A 2 (TWO) YEAR GUARANTEE.
2. PLANTED AREAS TO BE MAINTAINED AND PRUNED TO ENSURE GROWTH.
3. ALL PLANTED TREES ARE TO BE PLANTED A MINIMUM OF FIVE (5) FT. OUTSIDE OF ANY SANITARY SEWER OR STORM SEWER EASEMENT.

NO.	REVISION	DATE

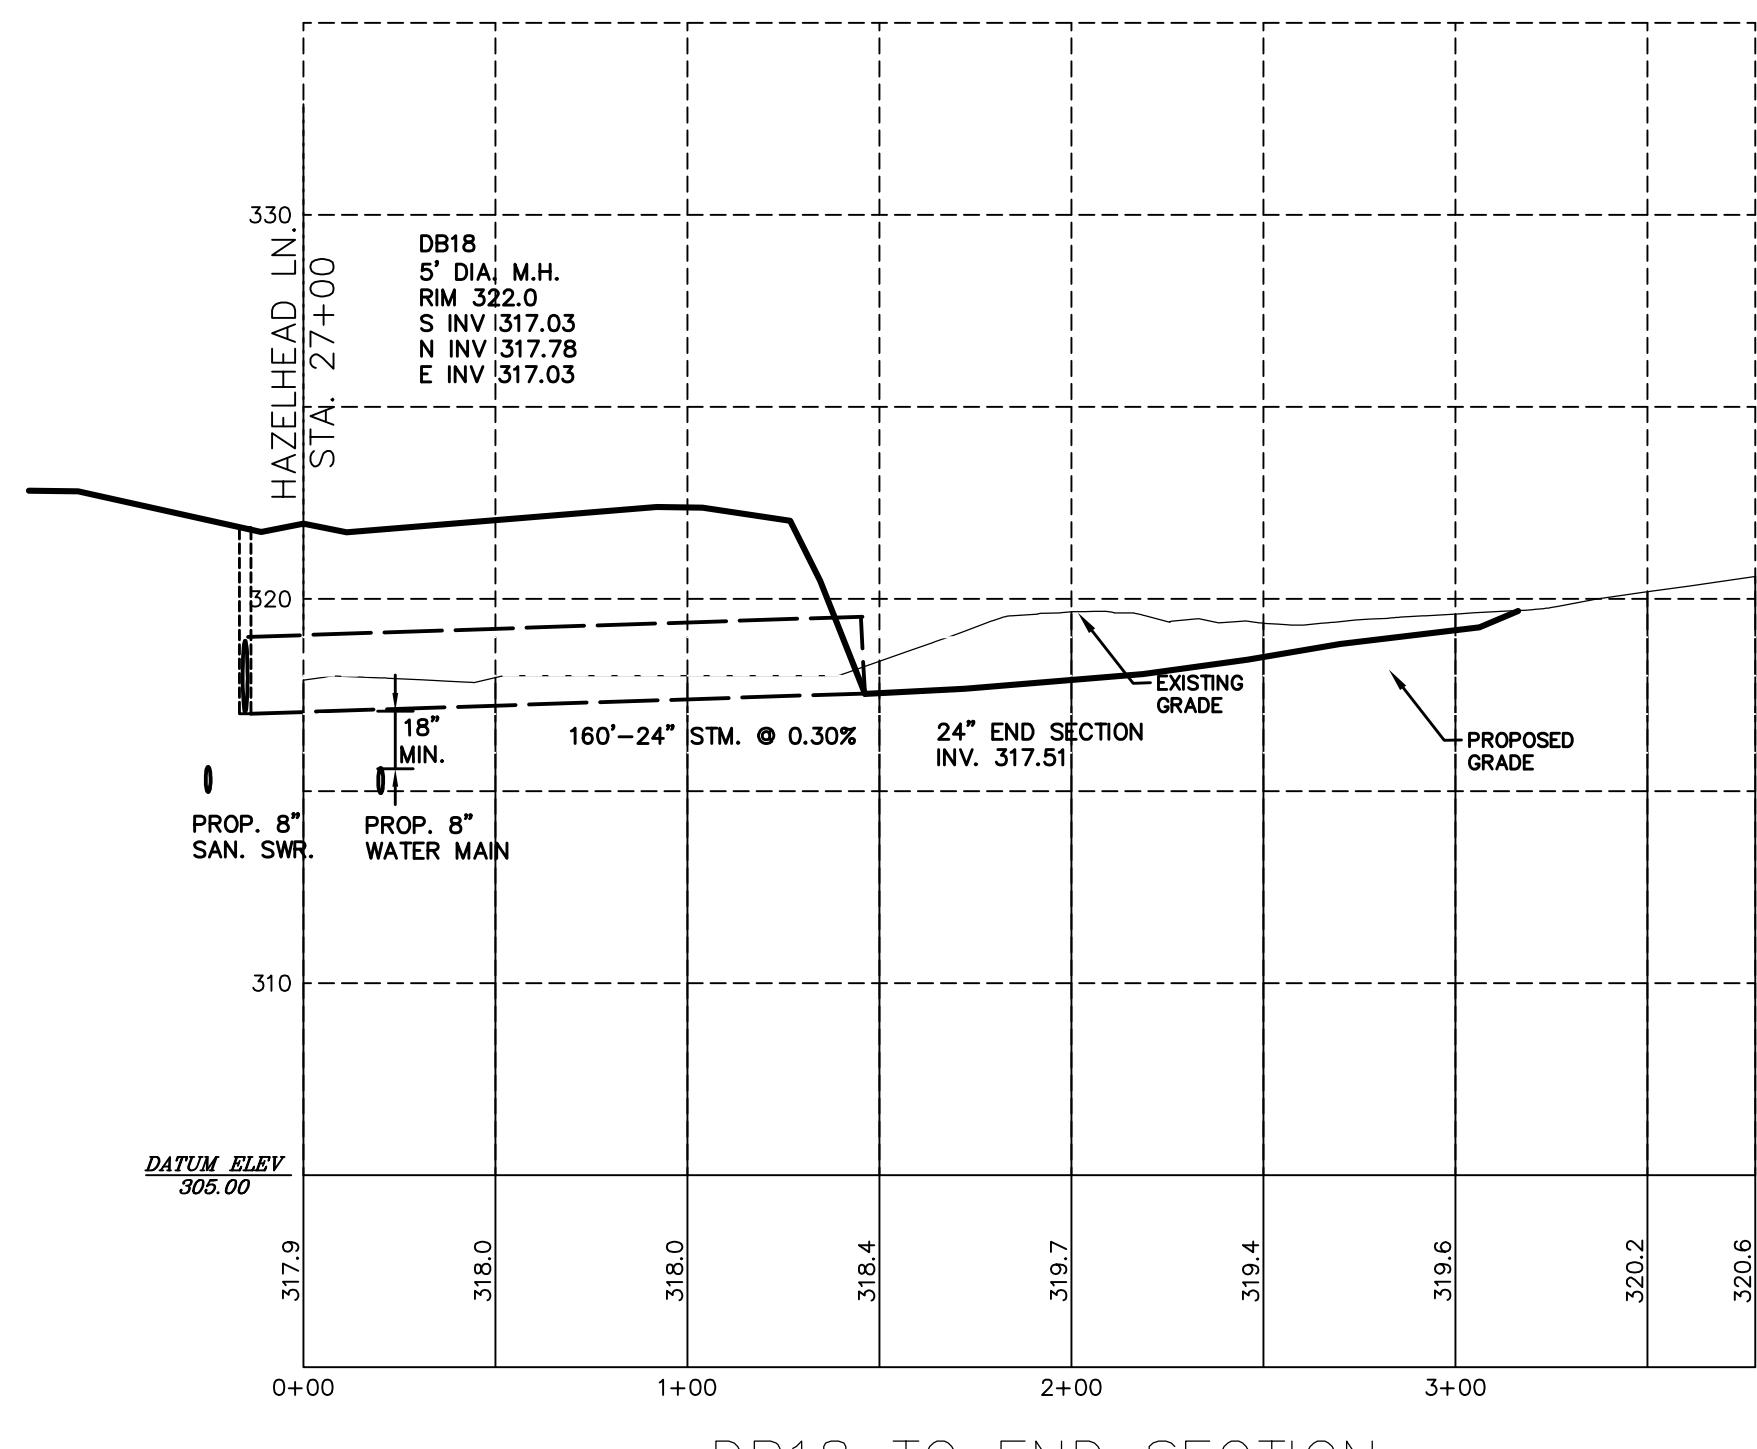
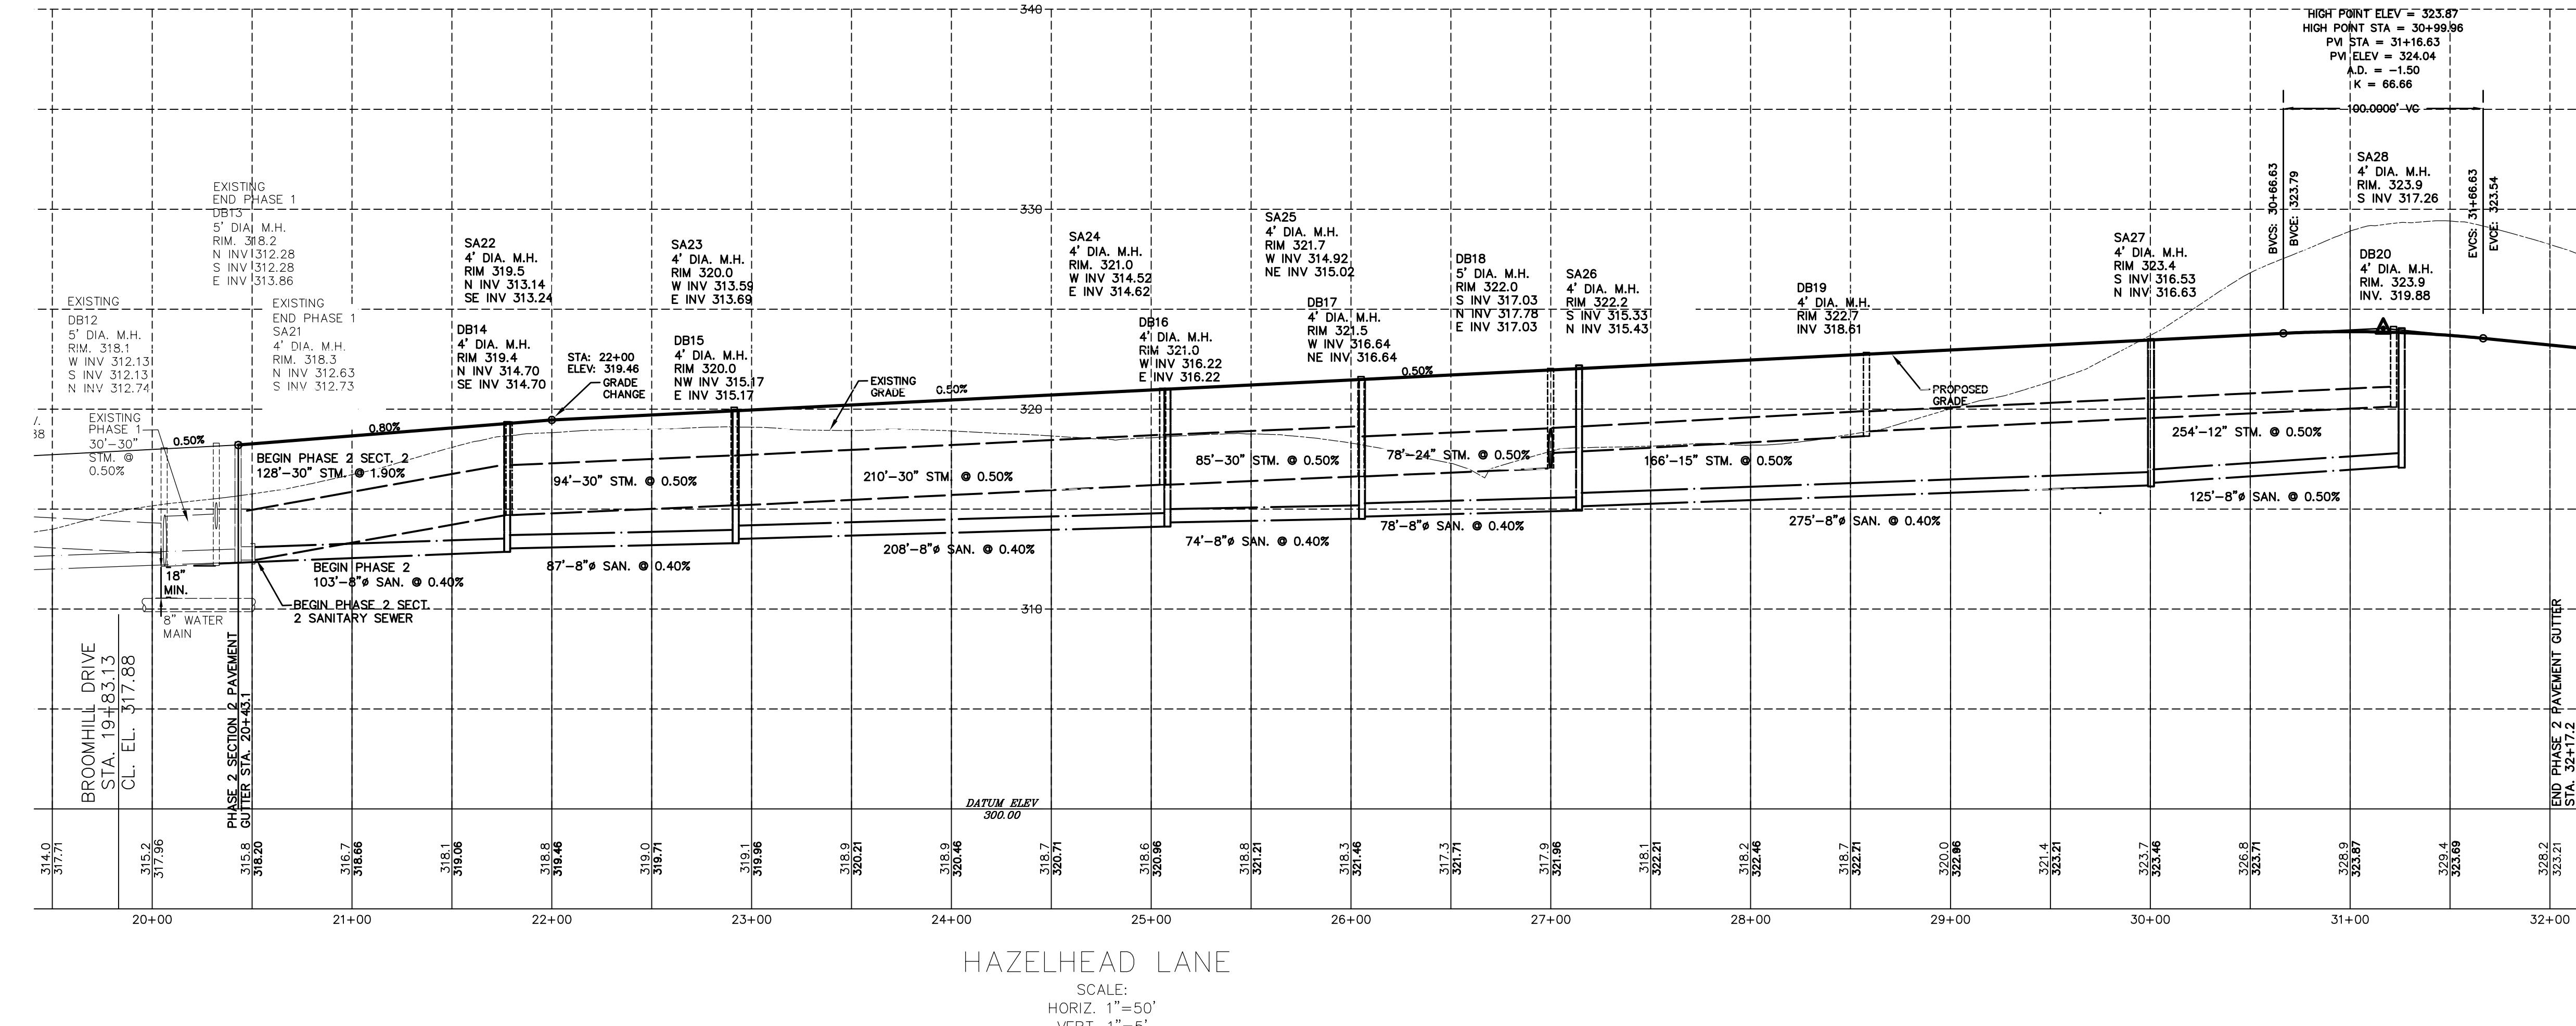
DSB Engineers and Architects, P.C.
250 Ridgeview Avenue, Suite 200, Rochester, New York 14605
ph. 585-271-5265 fax. 585-271-3465

PROJECT: ABERDEEN ESTATES SUBDIVISION
PART OF LOT 21 & 22, TOWNSHIP 14, RANGE 4 OF THE PELPS & ROCHAM PURCHASE, TOWN OF WEBSTER, MONROE COUNTY, NEW YORK

DRAWING TITLE: GRADING PLAN
FINAL PHASE 2

CLIENT: FOREST CREEK CONSTRUCTION
2540 CHELSEA AVENUE
ROCHESTER, NY 14624

PROJ. NO. 21-12034 Dwg. B.Y. M.F.B. APPROVED D.E.S. DATE 07/17/02 SCALE 1"=50'



NO.	REVISION	DATE



DSB Engineers and
Architects, P.C.

ph. 585-271-5230 fax 585-271-3488

DEEN ESTATES SUBDIVISION
11 & 23, TOWNSHIP 14, RANGE 4 OF THE PHELPS

11 & 23, TOWNSHIP 14, RANGE 4 OF THE THREE
CASE, TOWN OF WEBSTER, MONROE COUNTY, NEW
YORK.



PROFILES FINAL PHASE 2

FINAL PHASE 2

CREEK EQUITY CORP.
HILI AVENUE
TER, N.Y. 14624

DESIGN BY	APPROVED	DATE	SCALE	D
W.E.P.	250	01/13/26	AS NOTED	2


W.F.B.	D.E.S.	01/13/26	AS NOTED	6
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WASHOUT NOTES

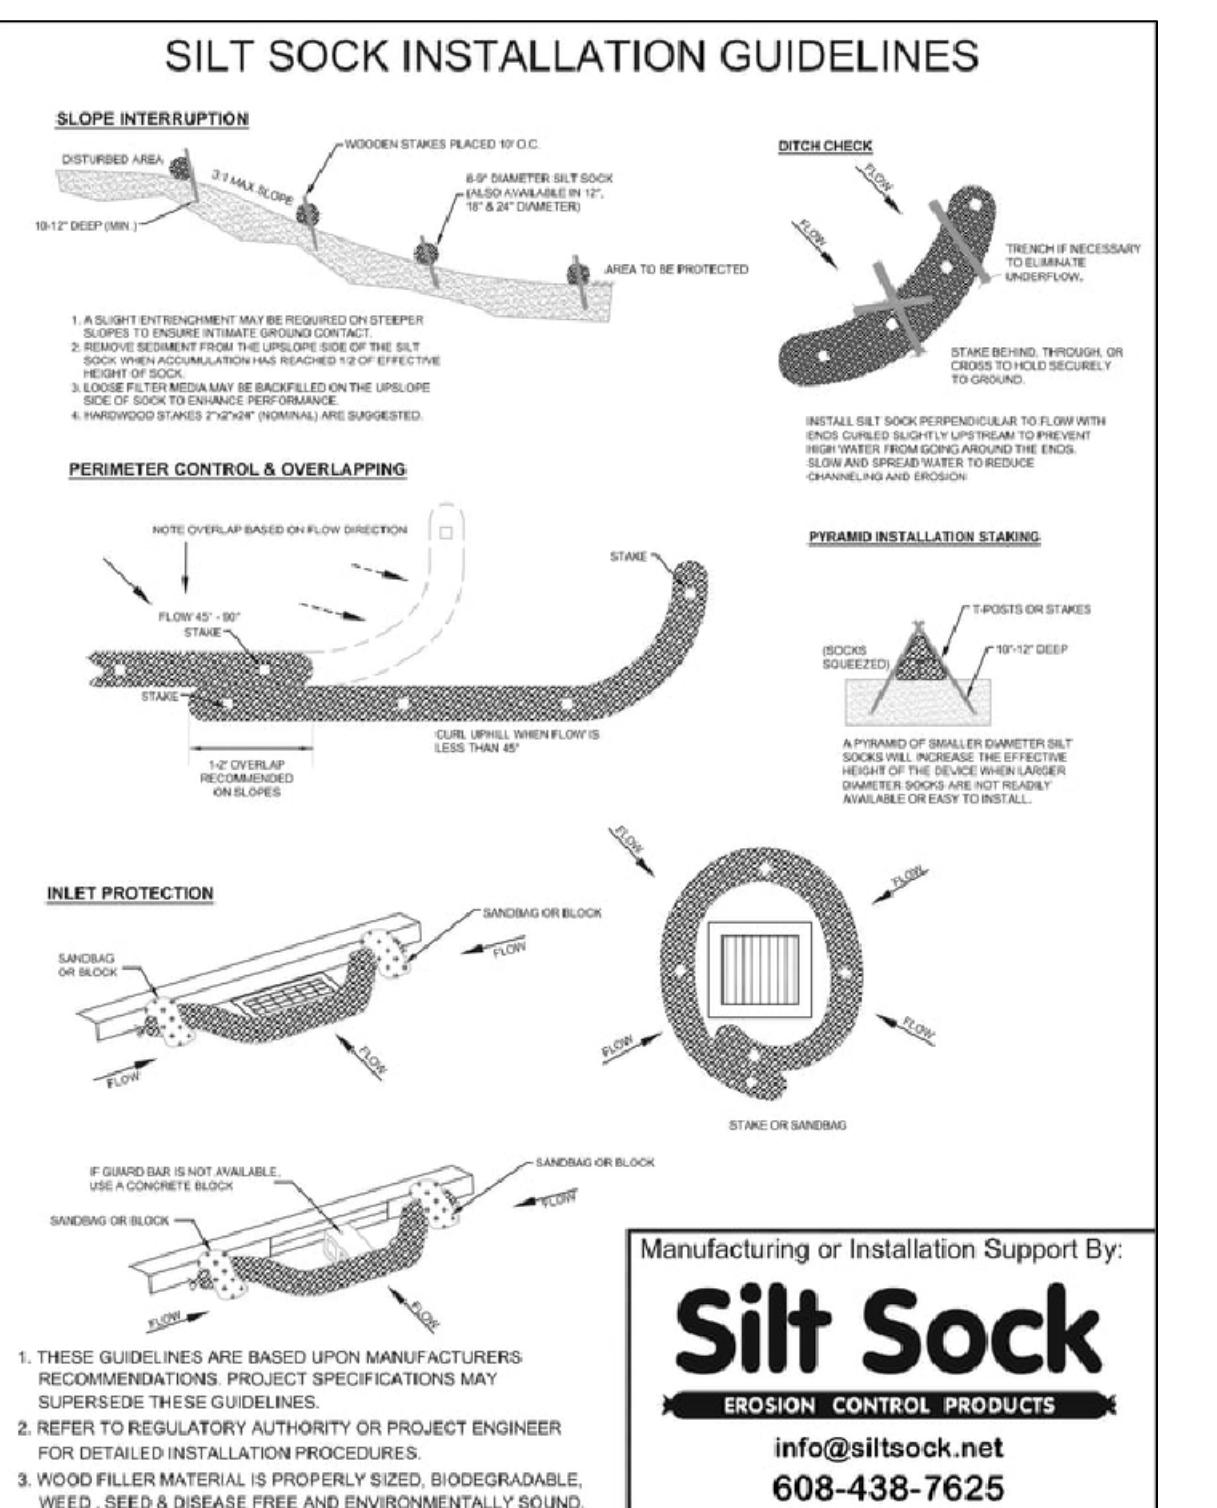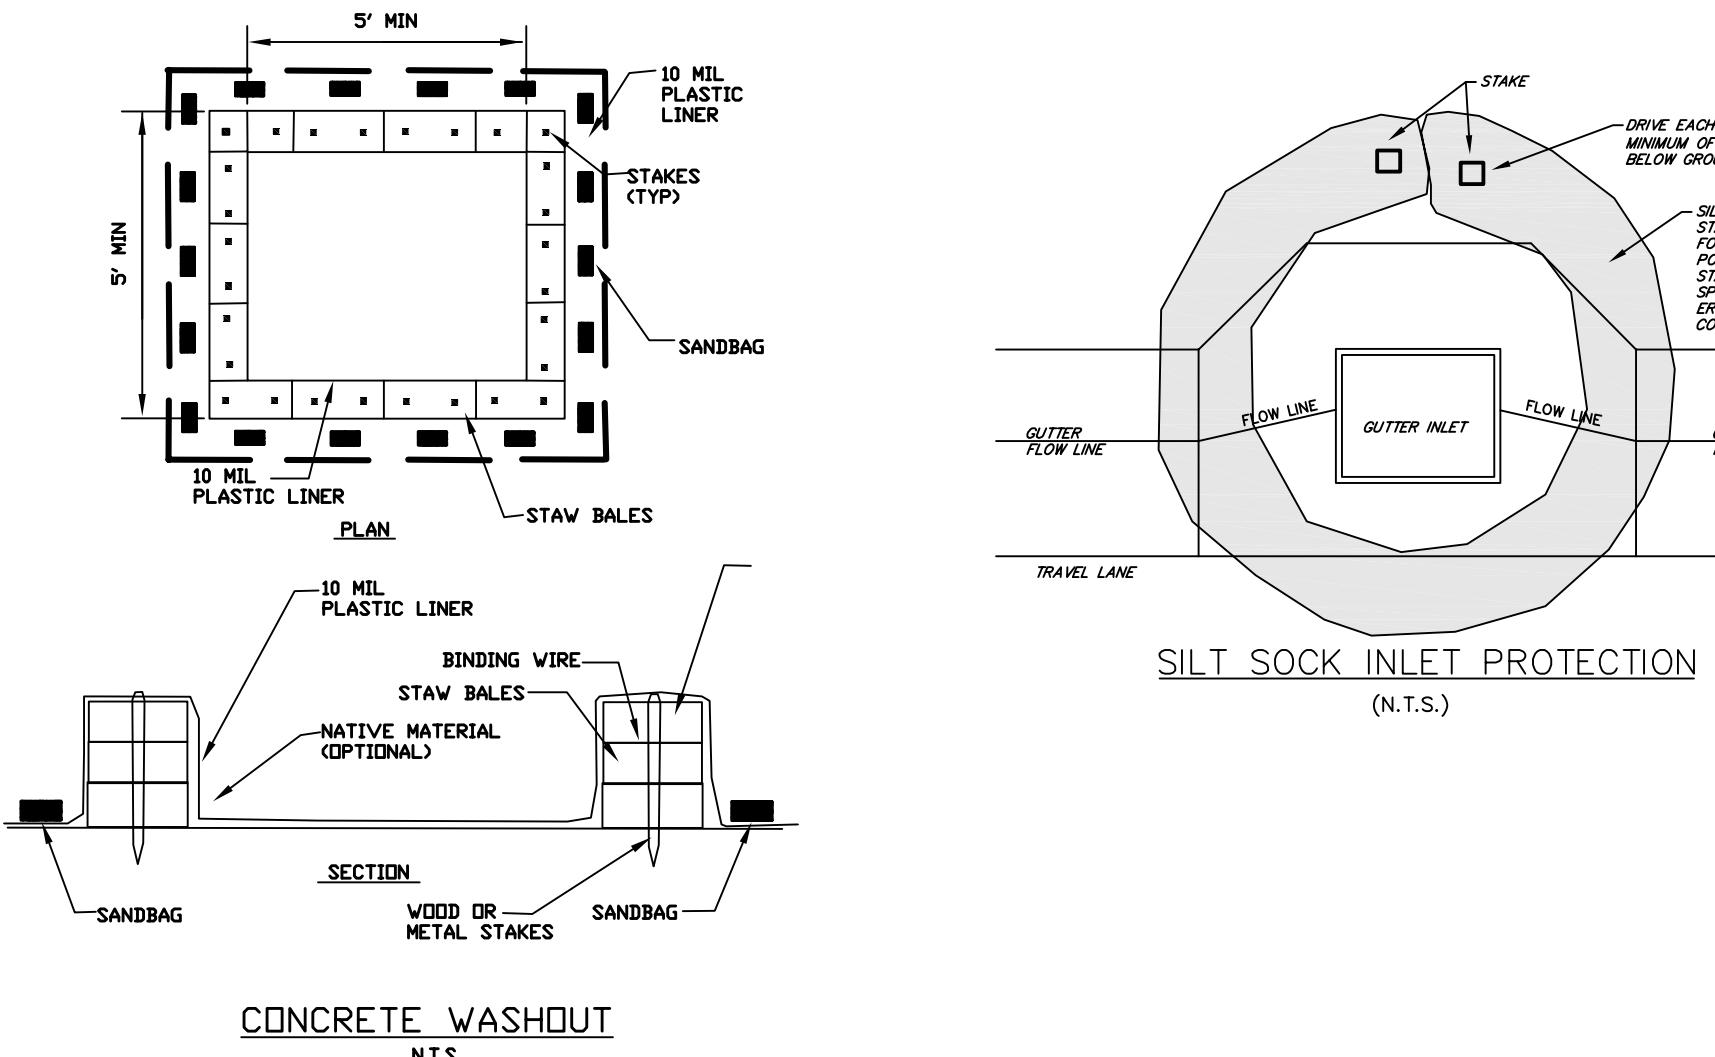1. NO WASHING OUT OF CONCRETE TRUCKS OR WASHING SWEPHS FOR PURPOSES OF REMOVING CONCRETE INTO STORM DRAINS, DITCHES, OR STREAMS IS ALLOWED.
2. EXCESS CONCRETE IS NOT ALLOWED TO BE DUMPED ON-SITE, EXCEPT IN DESIGNATED CONCRETE WASHOUT AREAS.
3. ON-SITE TEMPORARY CONCRETE WASHOUT AREAS WILL BE LOCATED AT LEAST 50 FEET FROM EXISTING CONCRETE AREAS.
4. TEMPORARY CONCRETE WASHOUT FACILITIES WILL BE CONSTRUCTED AND MAINTAINED IN ACCORDANCE WITH THE REQUIREMENTS OF THE CONCRETE WASHOUT OPERATOR.
5. PLASTIC WASHOUT AREAS WILL BE CLEANED OUT OR REPLACED ONCE THE WASHOUT IS 75% FULL.
6. PLASTIC WASHOUT AREAS WILL BE REMOVED AND DISPOSED OF AS FULL.
7. FREE OF HOLES, TEARS, OR OTHER DEFECTS.
8. CONCRETE WASHOUT AREAS WILL BE LOCATED AS REQUIRED FOR WORK, THE HARDED CONCRETE WILL BE REMOVED AND DISPOSED OF OFFSITE MATERIALS USED TO CONSTRUCT TEMPORARY CONCRETE WASHOUT FACILITIES WILL BE REMOVED FROM THE SITE AND DISPOSED OF.


Manufacturing or Installation Support By:
Silt Sock
EROSION CONTROL PRODUCTS
info@siltsock.net
608-438-7625



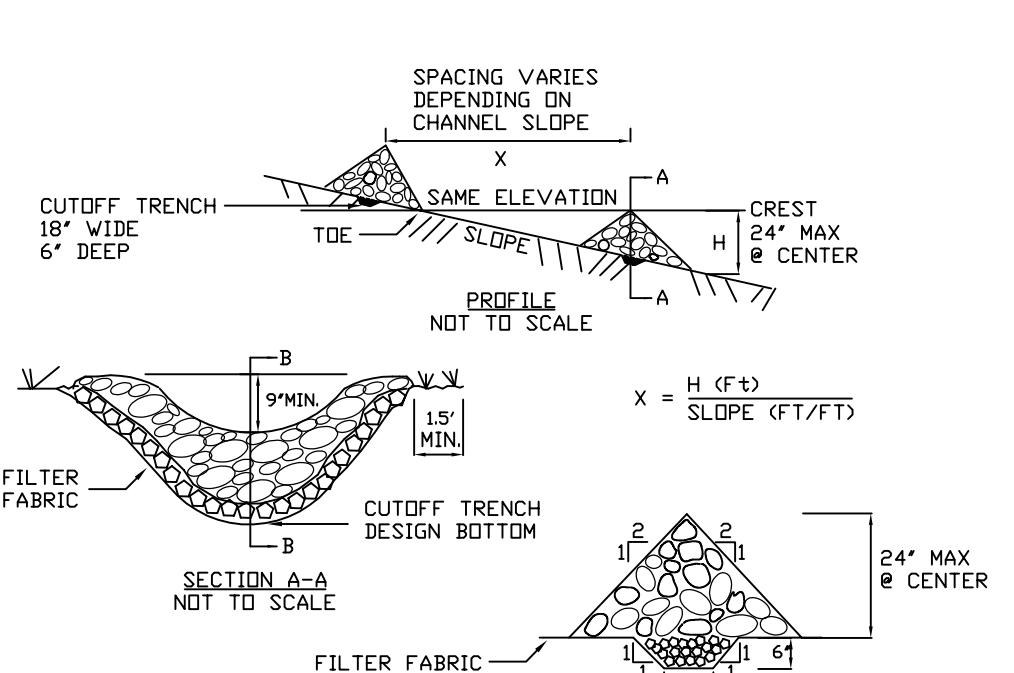CONSTRUCTION SPECIFICATIONS

1. WOVEN WIRE FENCE SHALL BE PLACED IN A FILTER FABRIC FOUNDATION TO THE LINES, GRADES AND LOCATIONS SHOWN IN THE PLAN.
2. SET SPACING OF CHECK DAM TO ASSUME THAT THE ELEVATIONS OF THE CREST AND THE STREAM DAM IS AT THE SAME ELEVATION AS THE TOE OF THE UPSTREAM DAM.
3. EXTEND THE STREAM DAM BY 15 FEET BEYOND THE DITCH BANKS TO PREVENT THE STREAM FROM DROWNING THE DAM.
4. CHECK DAM CHANNEL DOWNSTREAM OF THE LOWEST CHECK DAM FROM SCOUR AND EROSION WITH STONE OR LINER AS APPROPRIATE.
5. ENSURE THAT CHANNEL APPURTENANCES SUCH AS CULVERT ENTRANCES BELOW CHECK DAMS ARE NOT SUBJECT TO DAMAGE OR BLOCKAGE FROM DISPLACED STONE. MAXIMUM BRANISH AREA 2 ACRES.

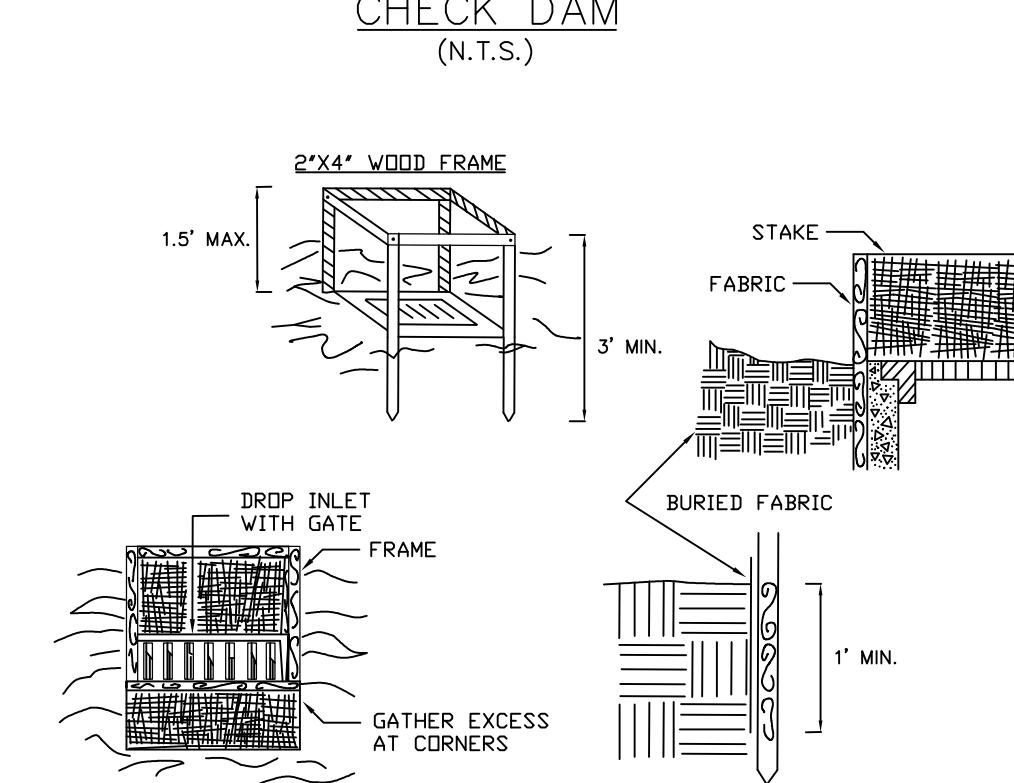CHECK DAM




CONSTRUCTION SPECIFICATIONS

1. FILTER FABRIC SHAL BE USED AS A 40-60 BURLAP MAY BE USED FOR SHORT TERM APPLICATION.
2. CUT FABRIC FOR A CONTINUOUS JUINION, IF NECESSARY, USE STAKE OR STAKE AND METAL WITH A MINIMUM LENGTH OF 3 FEET.
3. STAKE MATERIALS WILL BE STANDARD 2" X 4" WOOD OR EQUIVALENT.
4. FILTER CLOTH SHALL BE PLACED 12 INCHES APART AND DRIVE IN 18 INCHES DEEP. FILTER CLOTHS SHALL BE TIED TOGETHER WITH STAKE AND METAL.
5. FILTER CLOTH SHALL BE EMBEDDED 1 FOOT MINIMUM BELOW GROUND AND BACKFILLED IT SHALL BE SECURELY FASTENED TO THE FRAME.
6. FILTER FABRIC SHALL BE PLACED AROUND THE CREST AND BACKFILLED IT SHALL BE SECURELY FASTENED TO THE FRAME.
7. MAXIMUM DRAINAGE AREA 1 ACRE

FILTER FABRIC DROP INLET PROTECTION

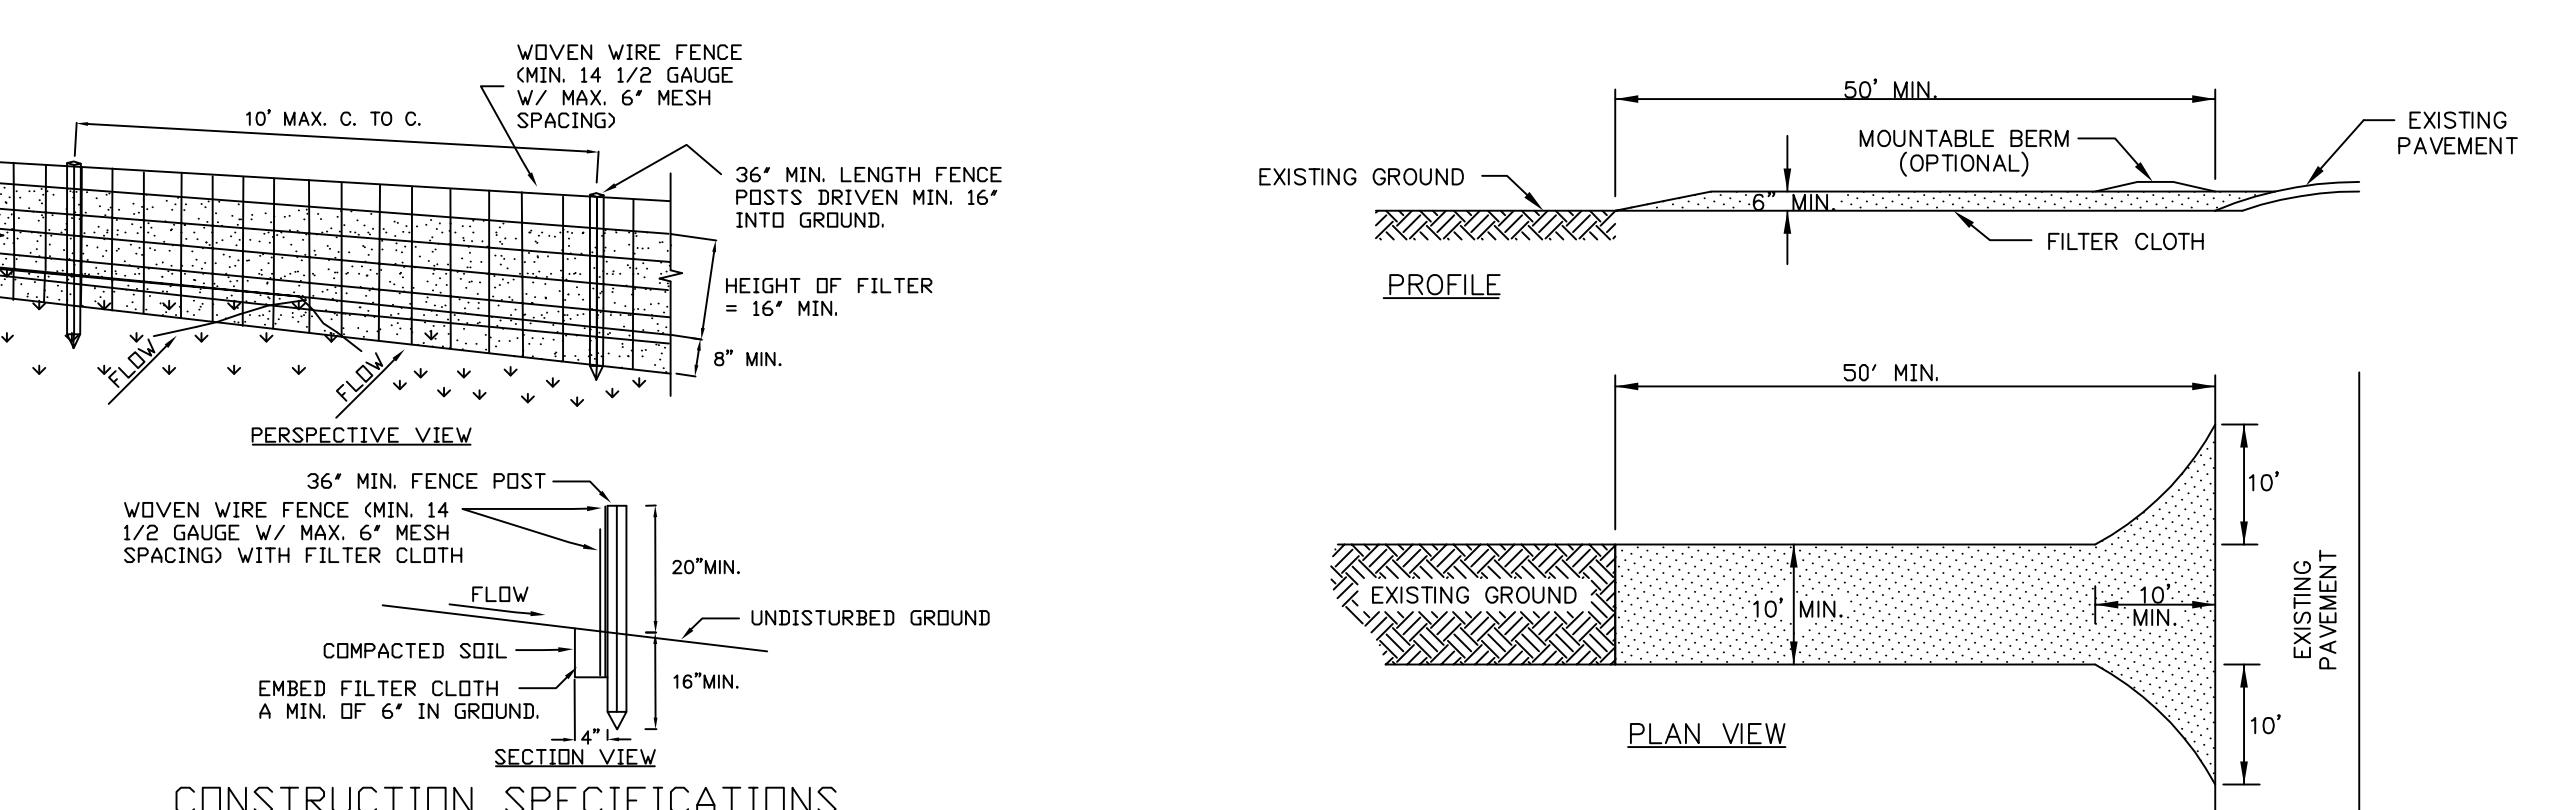(N.T.S.)



CONSTRUCTION SPECIFICATIONS

1. FILTER FABRIC FENCE SHALL BE USED AS A 40-60 BURLAP MAY BE USED FOR SHORT TERM APPLICATION.
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5. FILTER CLOTH SHALL BE EMBEDDED 1 FOOT MINIMUM BELOW GROUND AND BACKFILLED IT SHALL BE SECURELY FASTENED TO THE FRAME.
6. FILTER FABRIC SHALL BE PLACED OVER THE ENTIRE AREA PRIOR TO PLACING OF STONE.
7. MAINTENANCE - THE ENTRANCE SHALL BE MAINTAINED IN A CONDITION WHICH WILL PREVENT TRACKING OR FLOWING OF SEDIMENT ONTO PUBLIC RIGHT-OF-WAY. THIS MAY REQUIRE PERIODIC WASHING, CLEANING, REPAIRS, AND MAINTENANCE. MAINTENANCE SHALL BE PERFORMED AS NEEDED AND MATERIAL REMOVED WHEN "BULGES" DEVELOP IN THE FILTER FENCE.
8. WASHING - FILTER FABRIC SHALL BE CLEANED TO REMOVE SEDIMENT PRIOR TO ENTRANCE INTO PUBLIC RIGHT-OF-WAY. WHEN WASHING IS REQUIRED, IT SHALL BE DONE ON A 4' X 12' AREA COVERED WITH STONE AND WHICH DRAINS INTO AN APPROVED SEDIMENT TRAPPING DEVICE.
9. PERIODIC INSPECTION AND NEEDED MAINTENANCE SHALL BE PROVIDED AFTER EACH RAIN.

STABILIZED CONSTRUCTION ENTRANCE

(N.T.S.)



CONSTRUCTION SPECIFICATIONS

1. FILTER FABRIC SHAL BE USED AS A 40-60 BURLAP MAY BE USED FOR SHORT TERM APPLICATION.
2. LENGTH - AS REQUIRED, BUT NOT LESS THAN 100 FEET (EXCEPT ON A SINGLE RESIDENCE LOT WHERE A 30 FOOT MINIMUM LENGTH WOULD APPLY).
3. THICKNESS - NOT LESS THAN SIX (6) INCHES.
4. WIDTH - TEN (10) FEET MINIMUM, BUT NOT LESS THAN THE FULL WIDTH AT POINTS WHERE EGRESS OCCUR.
5. FILTER CLOTH SHALL BE PLACED OVER THE ENTIRE AREA PRIOR TO PLACING OF STONE.
6. SURFACE WATER - ALL SURFACE WATER FLOWING OR DIVERTED TOWARD CONSTRUCTION ENTRANCES SHALL BE PIPED ACROSS THE ENTRANCE. IF PIPING IS IMPRACTICAL, A MINIMUM 12" DIA. DRAINAGE DITCHES SHALL BE PROVIDED.
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STABILIZED CONSTRUCTION ENTRANCE

N.T.S.

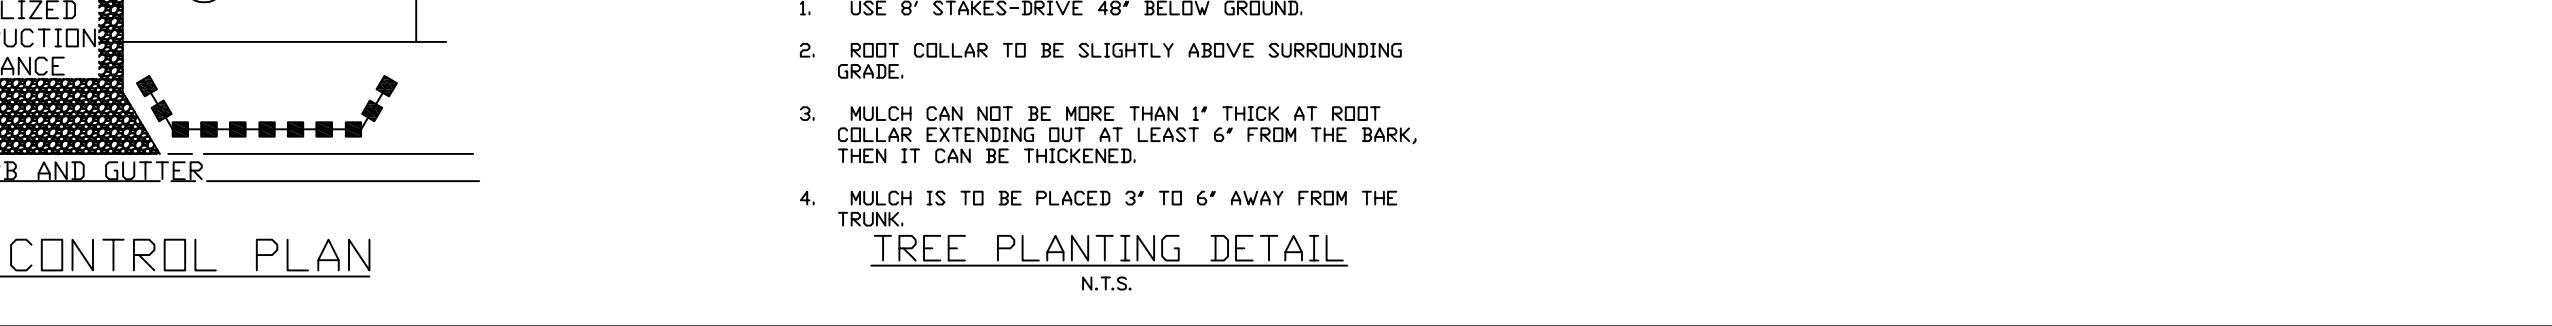


CONSTRUCTION SPECIFICATIONS

1. FILTER FABRIC SHAL BE USED AS A 40-60 BURLAP MAY BE USED FOR SHORT TERM APPLICATION.
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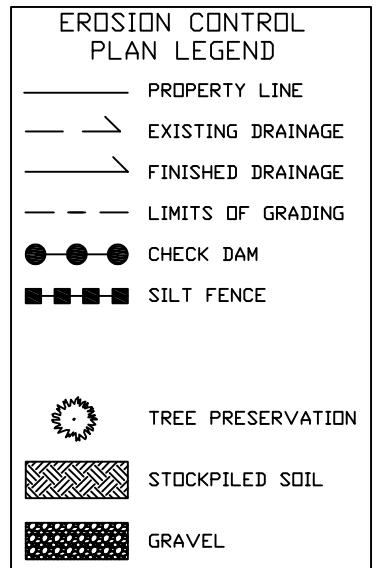
STABILIZED CONSTRUCTION ENTRANCE

N.T.S.



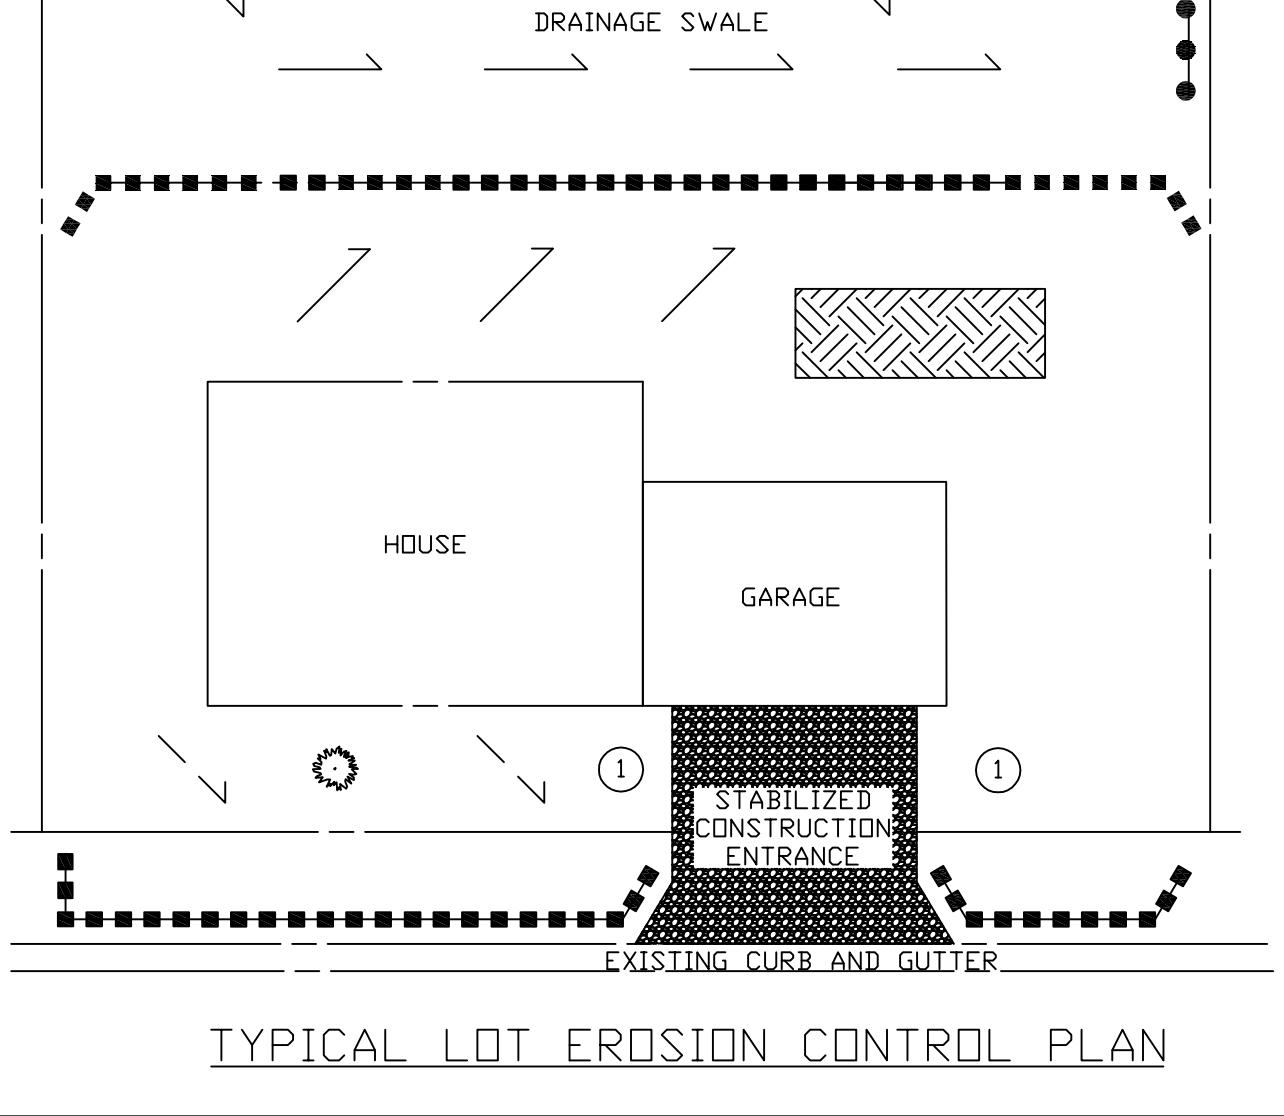
CONSTRUCTION SPECIFICATIONS

1. FILTER FABRIC SHAL BE USED AS A 40-60 BURLAP MAY BE USED FOR SHORT TERM APPLICATION.
2. LENGTH - AS REQUIRED, BUT NOT LESS THAN 100 FEET (EXCEPT ON A SINGLE RESIDENCE LOT WHERE A 30 FOOT MINIMUM LENGTH WOULD APPLY).
3. THICKNESS - NOT LESS THAN SIX (6) INCHES.
4. WIDTH - TEN (10) FEET MINIMUM, BUT NOT LESS THAN THE FULL WIDTH AT POINTS WHERE EGRESS OCCUR.
5. FILTER CLOTH SHALL BE PLACED OVER THE ENTIRE AREA PRIOR TO PLACING OF STONE.
6. SURFACE WATER - ALL SURFACE WATER FLOWING OR DIVERTED TOWARD CONSTRUCTION ENTRANCES SHALL BE PIPED ACROSS THE ENTRANCE. IF PIPING IS IMPRACTICAL, A MINIMUM 12" DIA. DRAINAGE DITCHES SHALL BE PROVIDED.
7. MAINTENANCE - THE ENTRANCE SHALL BE MAINTAINED IN A CONDITION WHICH WILL PREVENT TRACKING OR FLOWING OF SEDIMENT ONTO PUBLIC RIGHT-OF-WAY. THIS MAY REQUIRE PERIODIC WASHING, CLEANING, REPAIRS, AND MAINTENANCE. MAINTENANCE SHALL BE PERFORMED AS NEEDED AND MATERIAL REMOVED WHEN "BULGES" DEVELOP IN THE FILTER FENCE.
8. WASHING - FILTER FABRIC SHALL BE CLEANED TO REMOVE SEDIMENT PRIOR TO ENTRANCE INTO PUBLIC RIGHT-OF-WAY. WHEN WASHING IS REQUIRED, IT SHALL BE DONE ON A 4' X 12' AREA COVERED WITH STONE AND WHICH DRAINS INTO AN APPROVED SEDIMENT TRAPPING DEVICE.
9. PERIODIC INSPECTION AND NEEDED MAINTENANCE SHALL BE PROVIDED AFTER EACH RAIN.




NOTES:
1. 100% erosion slopes, up to 8 percent, see fence and stave notes below for support.

2. Slopes exceeding 25 percent shall have site fence backed by street swale for support.




TYPICAL LOT EROSION CONTROL PLAN

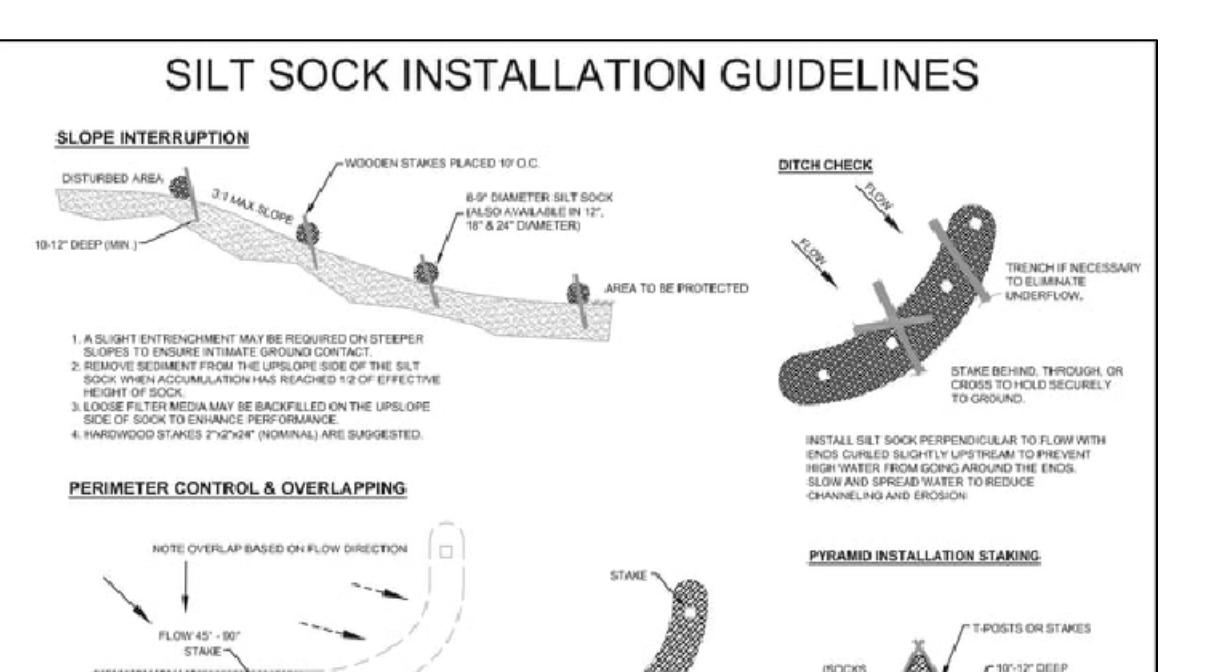N.T.S.




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SECTION R-B
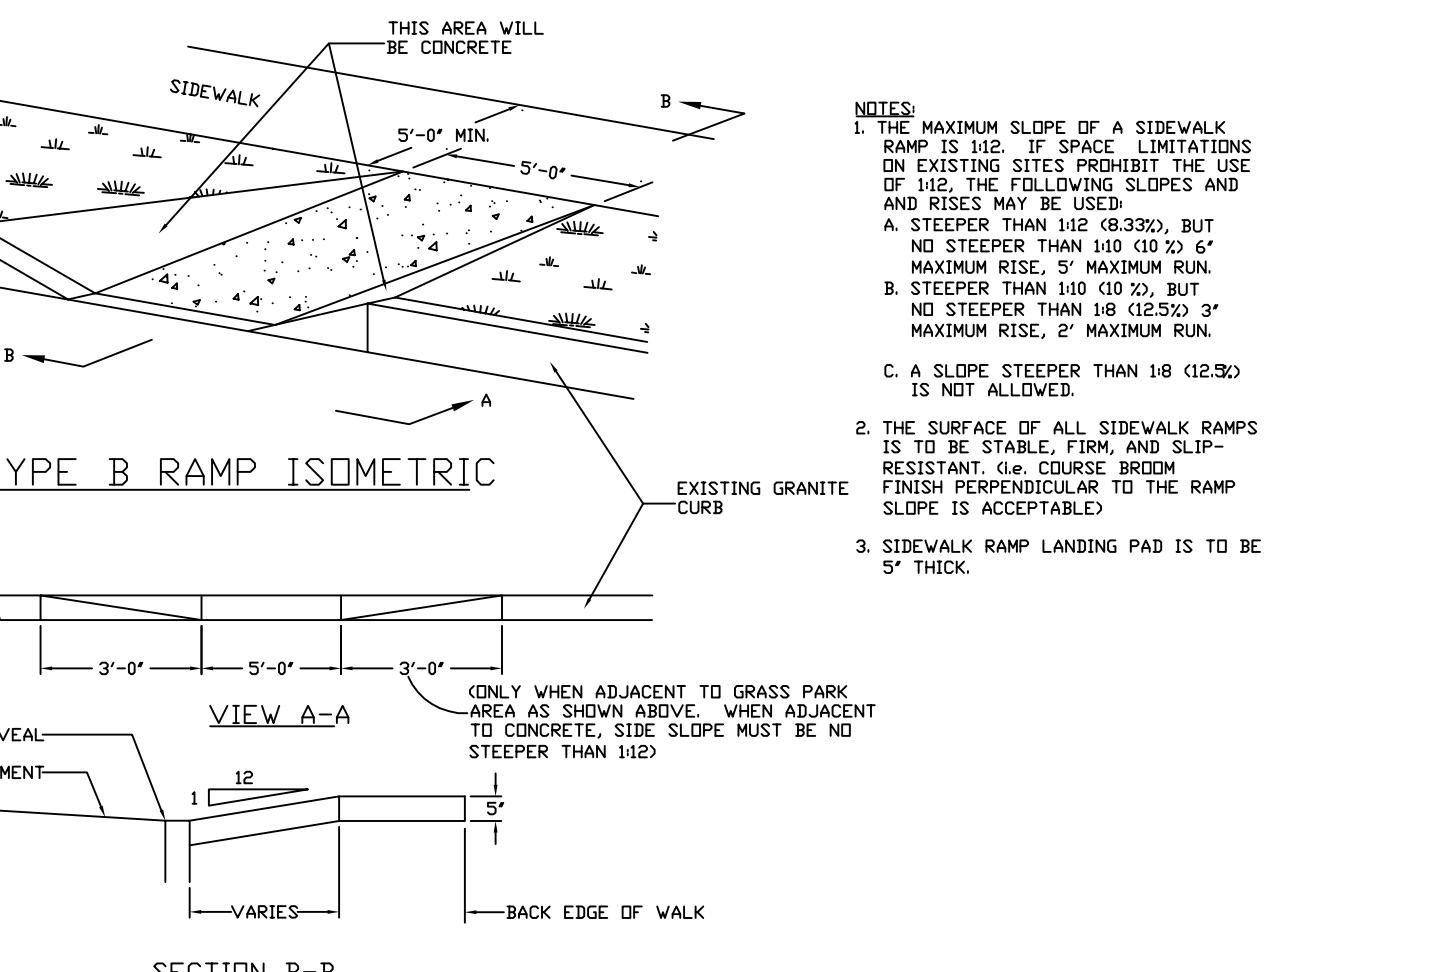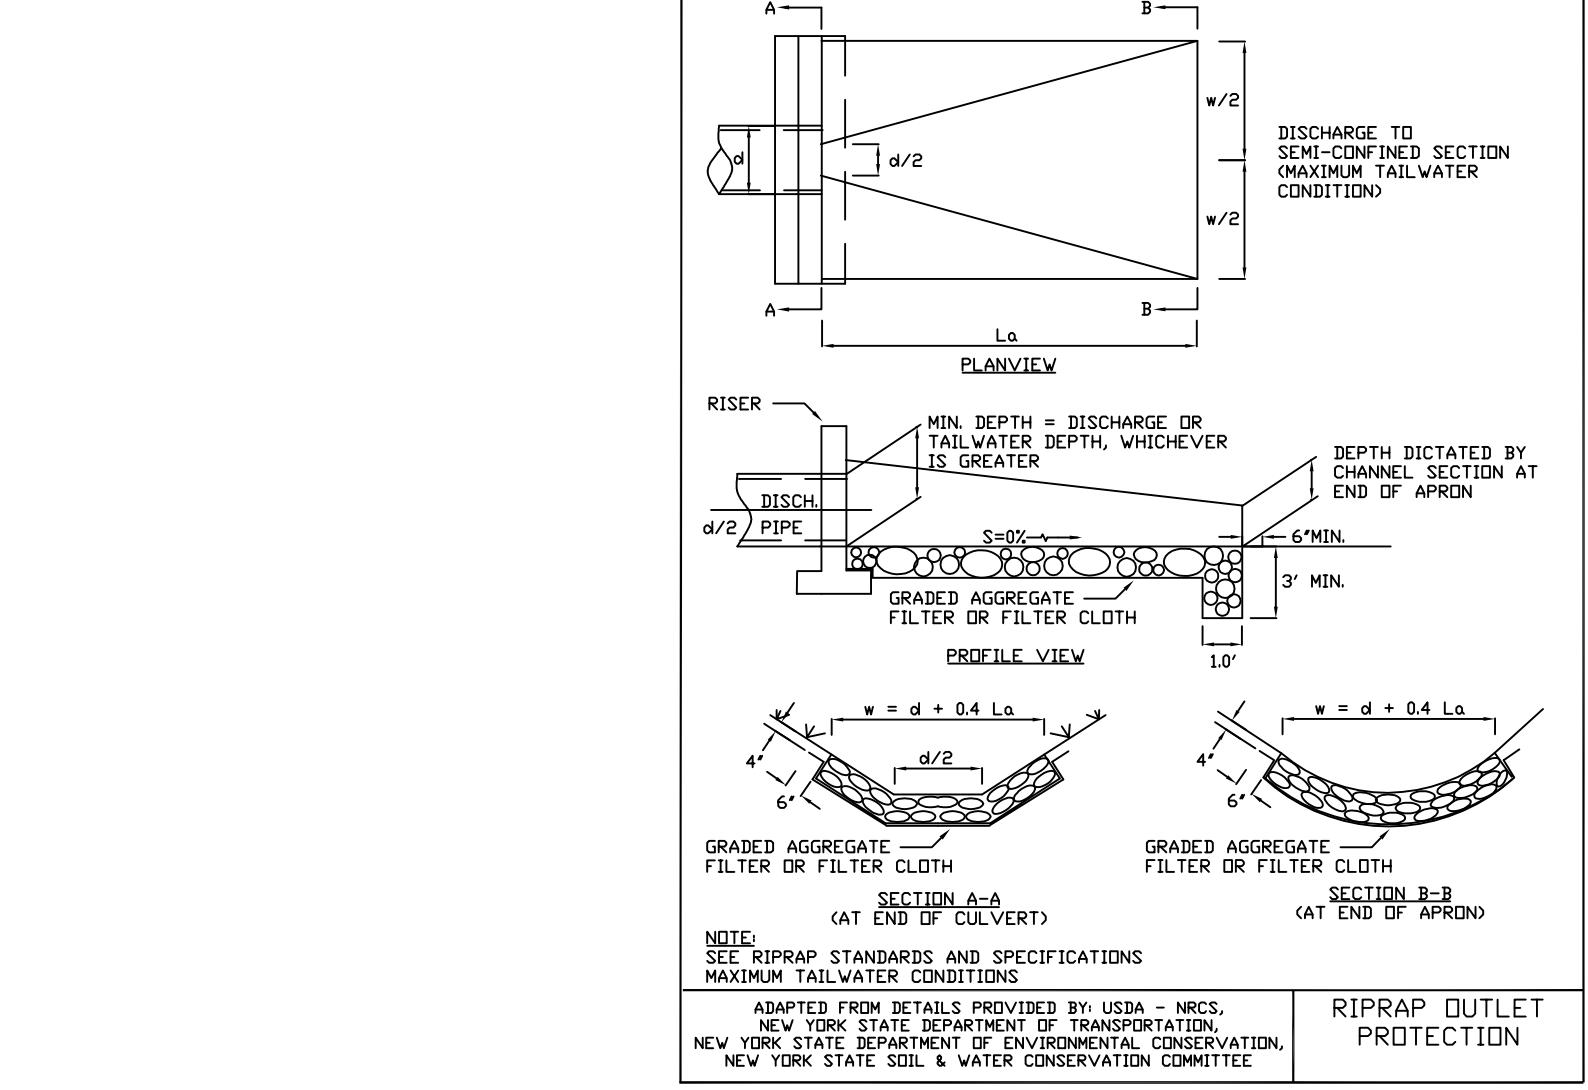
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